04/21/2021 REVISION INCORPORATING CO 01, CO 02, & CO 04

OWNER/APPLICANT

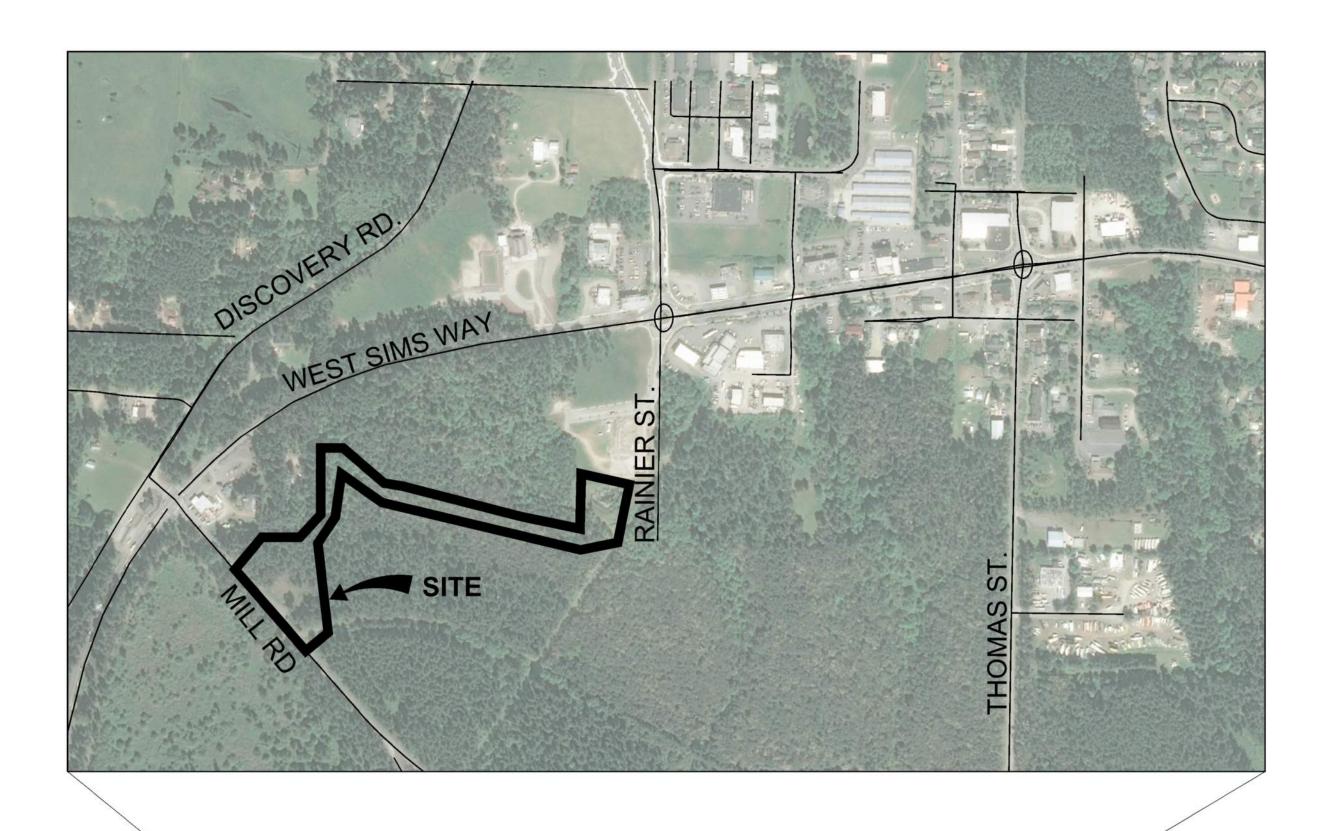
CITY OF PORT TOWNSEND 250 MADISON STREET PORT TOWNSEND, WA 98368 PHONE: 360-379-5096 CONTACT: DAVID PETERSON, PE EMAIL: DPETERSON@CITYOFPT.US

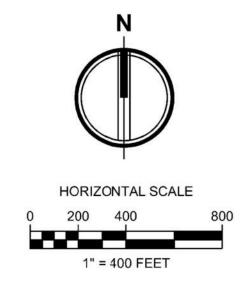
CIVIL ENGINEER

2215 NORTH 30TH STREET, SUITE 300 TACOMA, WA 98403 PHONE: (253) 383-2422 CONTACT: DAN OSIER, PE EMAIL: DOSIER@AHBL.COM

SURVEYOR

PHONE: 360-683-3438 CONTACT: BRIAN VAN ALLER, PLS EMAIL: VANSURV@OLYPEN.COM






VERTICAL DATUM

NORTH AMERICAN VERTICAL DATUM (NAVD) OF 1988

BASIS OF BEARING

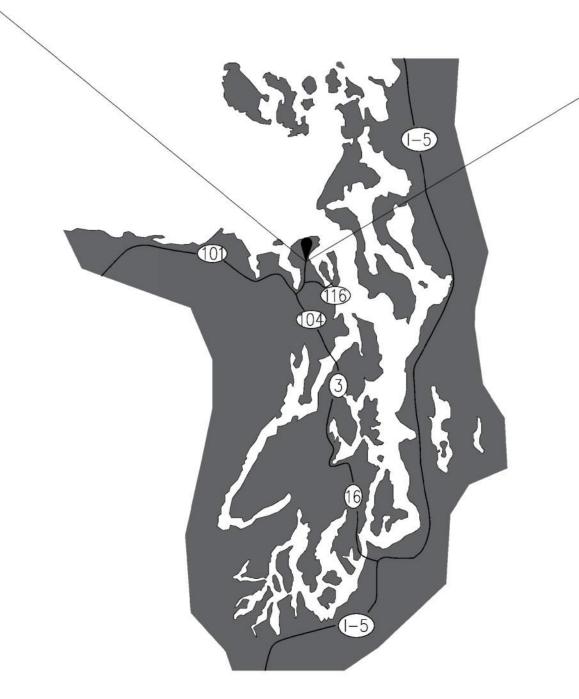WASHINGTON COORDINATE SYSTEM OF 1983, ADJUSTMENT 1991, NORTH ZONE, NORTH AMERICAN DATUM (NAD 83/91)



SHEET INDEX SHT # DESCRIPTION C0.00 COVER SHEET C0.02 HORIZONTAL CONTROL AND ACCESS PLAN C0.03 HORIZONTAL CONTROL AND ACCESS PLAN 1.00 TESC AND DEMOLITION PLAN 1.01 TESC AND DEMOLITION PLAN 1.10 TESC AND DEMOLITION DETAILS AND NOTES 2.01 GRADING, STORM, AND SURFACING PLAN C2.02 GRADING, STORM, AND SURFACING PLAN 2.03 GRADING, STORM, AND SURFACING PLAN 2.04 GRADING, STORM, AND SURFACING PLAN 3.10 STORM DRAINAGE DETAILS C3.11 STORM DRAINAGE DETAILS C3.12 STORM DRAINAGE DETAILS

C4.01 REVISED POND PROFILES

C4.00 BID ALTERNATE STORM INFILTRATION PLAN REVISED STORM INFILTRATION PLAN 2215 North 30th Street, Suite 300 Tacoma, WA 98403

253.383.2422 TEL 253.383.2572 FAX www.ahbl.com WEB Project Title:

PORT TOWNSEND **REGIONAL STORMWATER FACILITY**

CITY OF PORT TOWNSEND

250 MADISON STREET PORT TOWNSEND, WA 98368

WORK ORDER # 8028

Project No.

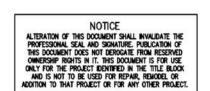
Issue Set & Date:

03/19/2020

BID SET

2160137





CHANGE ORDER 04

04/21/2021

CHANGE ORDER 02

↑ CHANGE ORDER 01

Sheet Title:

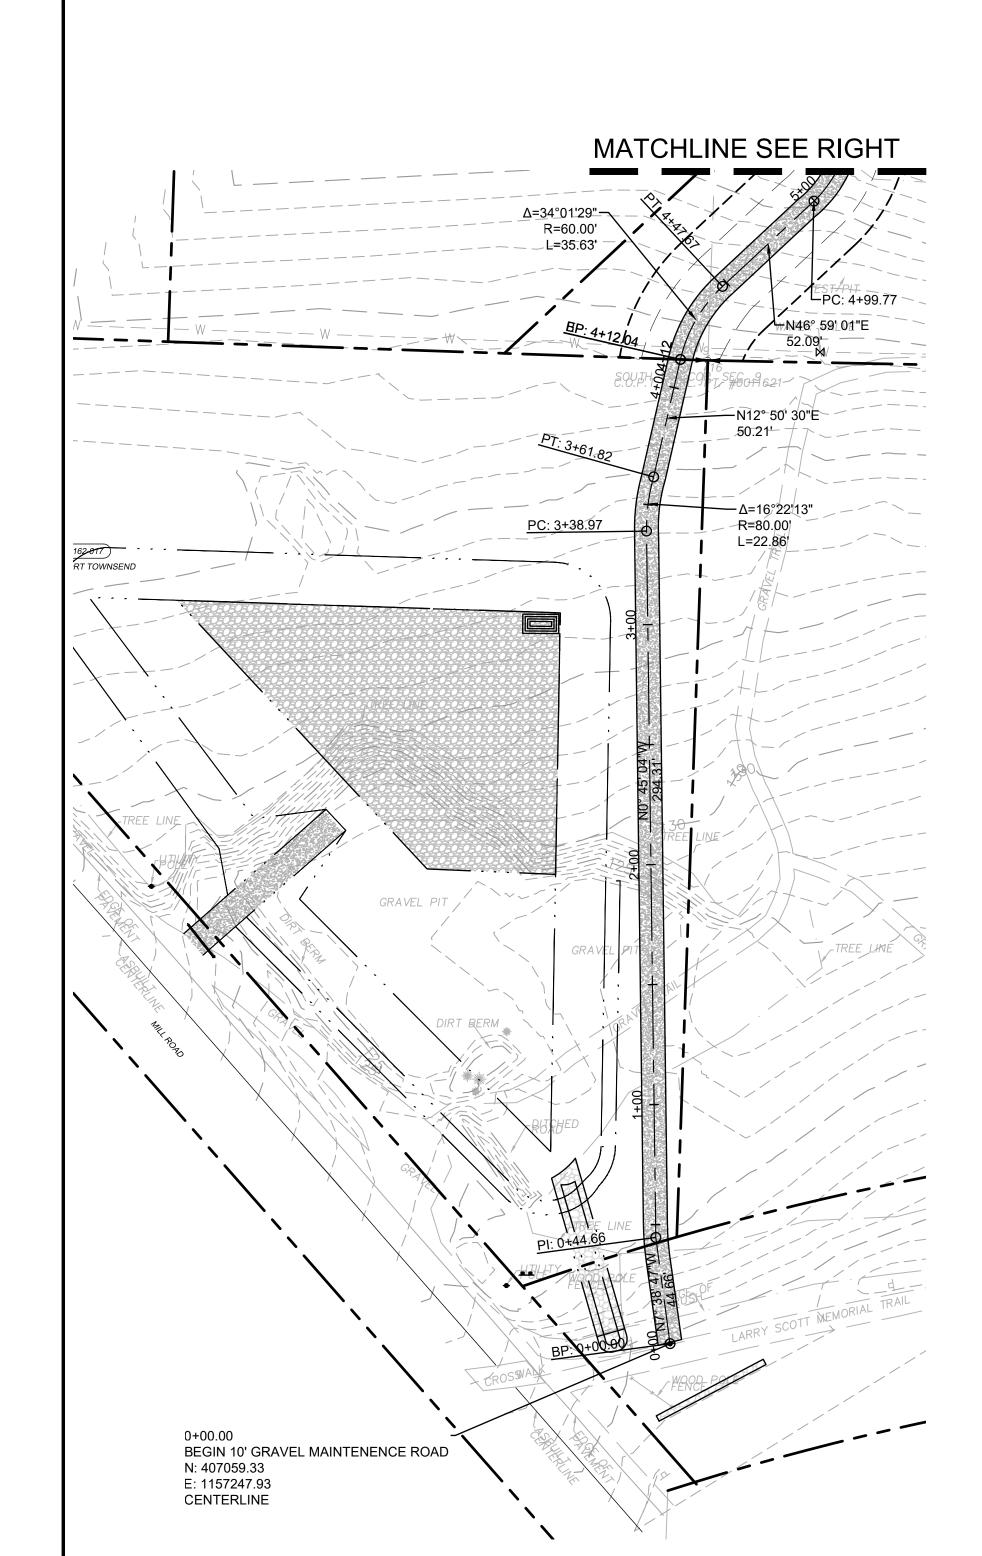
COVER SHEET

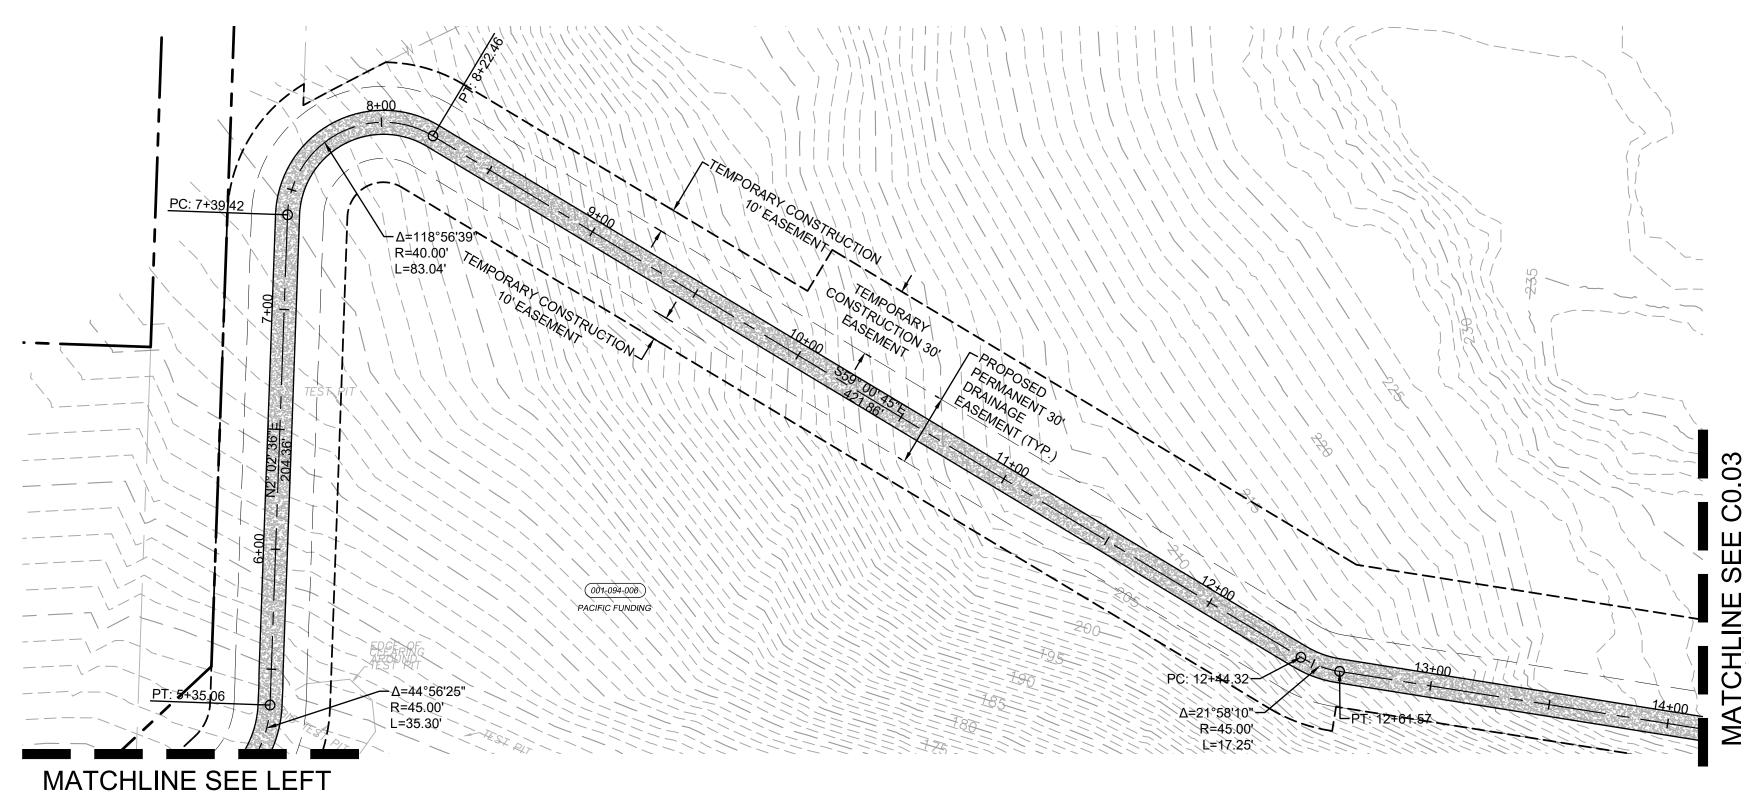
Drawn by:

Checked by:


Sheet No.







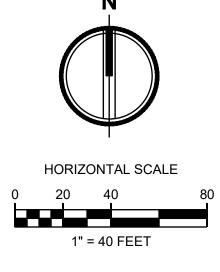LEGEND ----— — —XXX— — EXISTING MAJOR CONTOUR





PORT TOWNSEND REGIONAL STORMWATER FACILITY

CITY OF PORT TOWNSEND

250 MADISON STREET PORT TOWNSEND, WA 98368

WORK ORDER # 8028


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Issue Set & Date:

BID SET

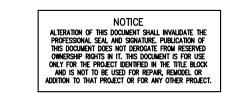03/19/2020





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CHANGE ORDER 02 03/19/2021

CHANGE ORDER 04 04/21/2021

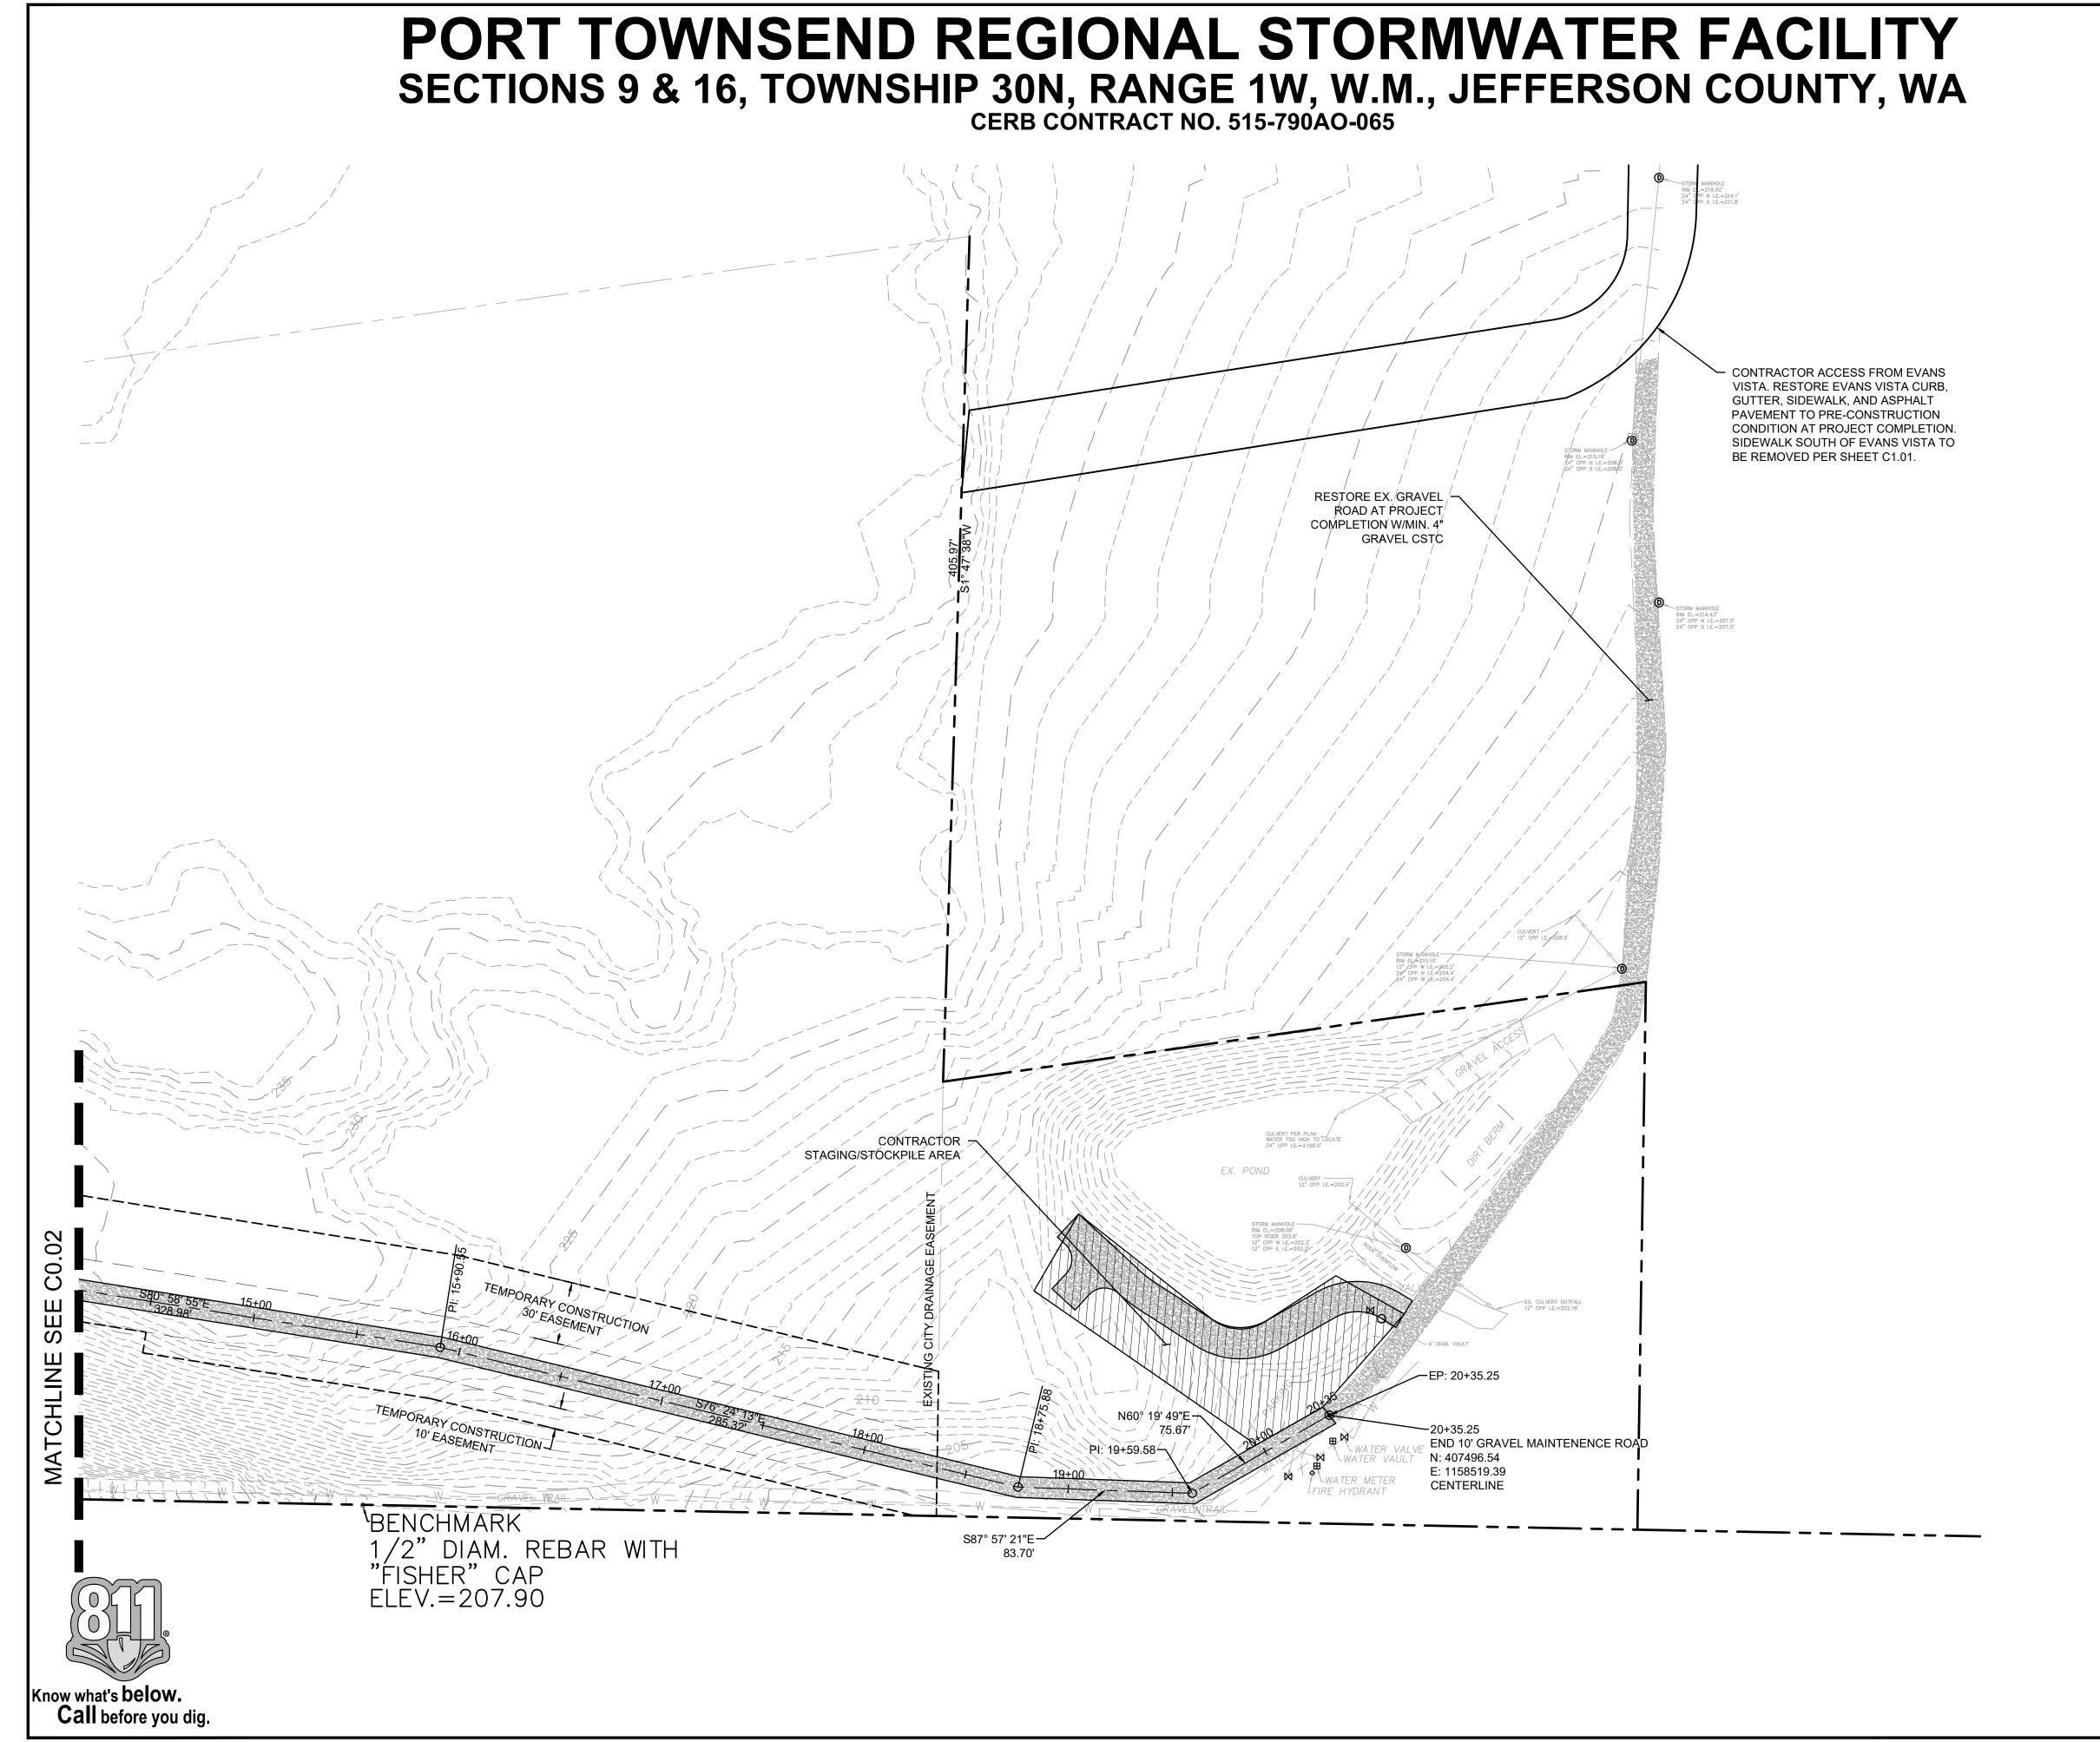
↑ CHANGE ORDER 01 12/17/2020 Revisions:

Sheet Title:

HORIZONTAL CONTROL AND ACCESS PLAN

Designed by: Drawn by: Checked by:

Sheet No.





Project Title: **PORT TOWNSEND REGIONAL STORMWATER FACILITY**

CITY OF PORT TOWNSEND

250 MADISON STREET PORT TOWNSEND, WA 98368

WORK ORDER # 8028

Project No.

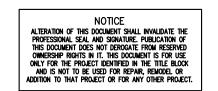
2160137

Issue Set & Date:

BID SET

03/19/2020





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CHANGE ORDER 04 04/21/2021

CHANGE ORDER 02 03/19/2021

CHANGE ORDER 01
12/17/2020
Revisions:

Sheet Title:

HORIZONTAL CONTROL AND ACCESS PLAN

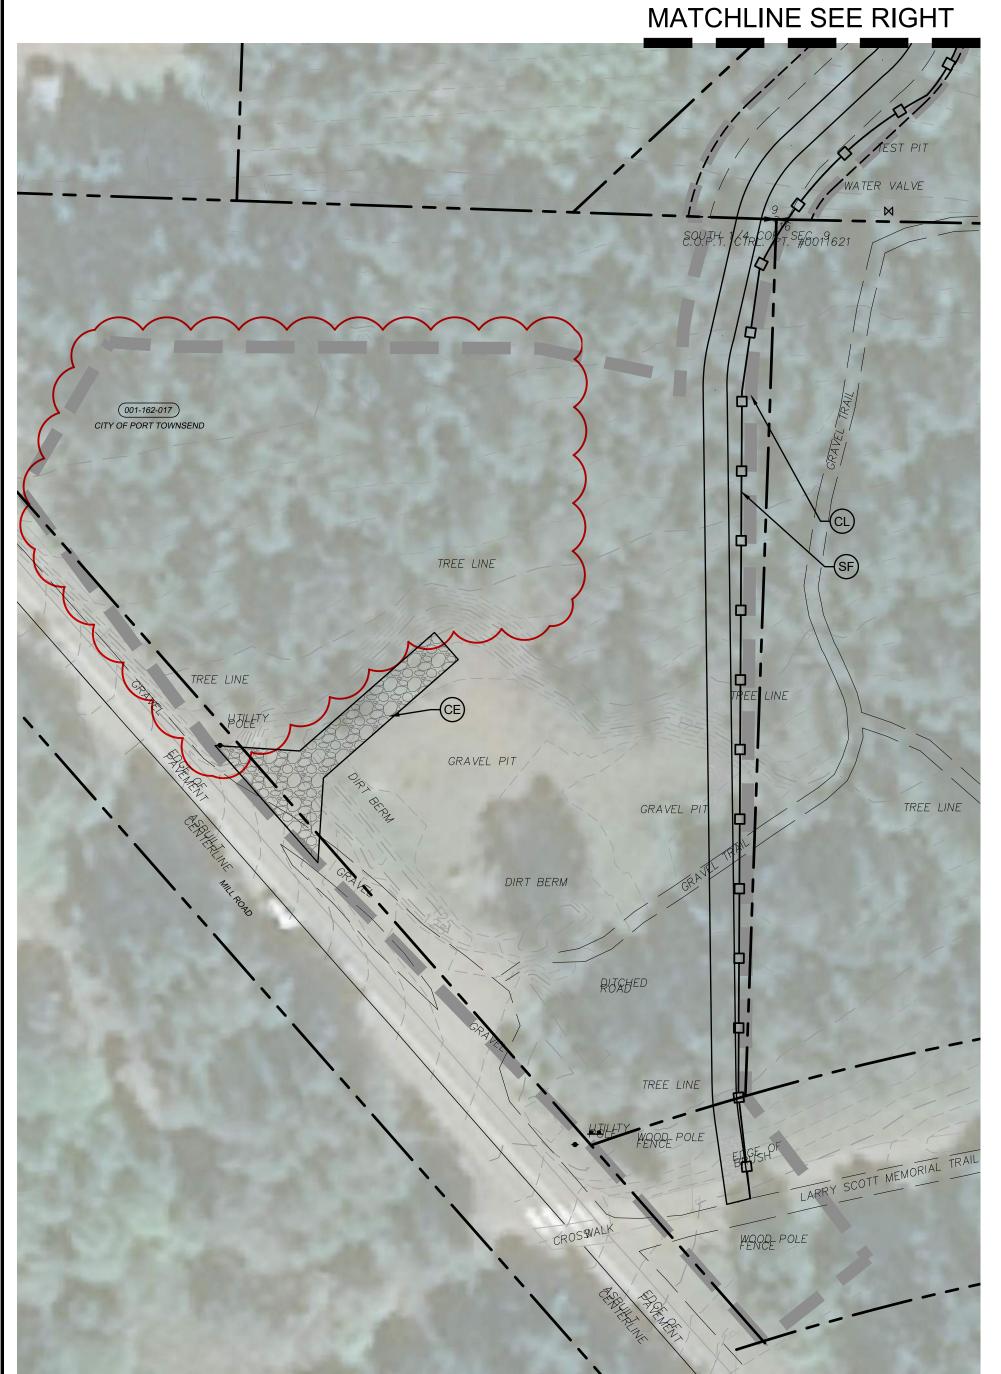
HORIZONTAL SCALE

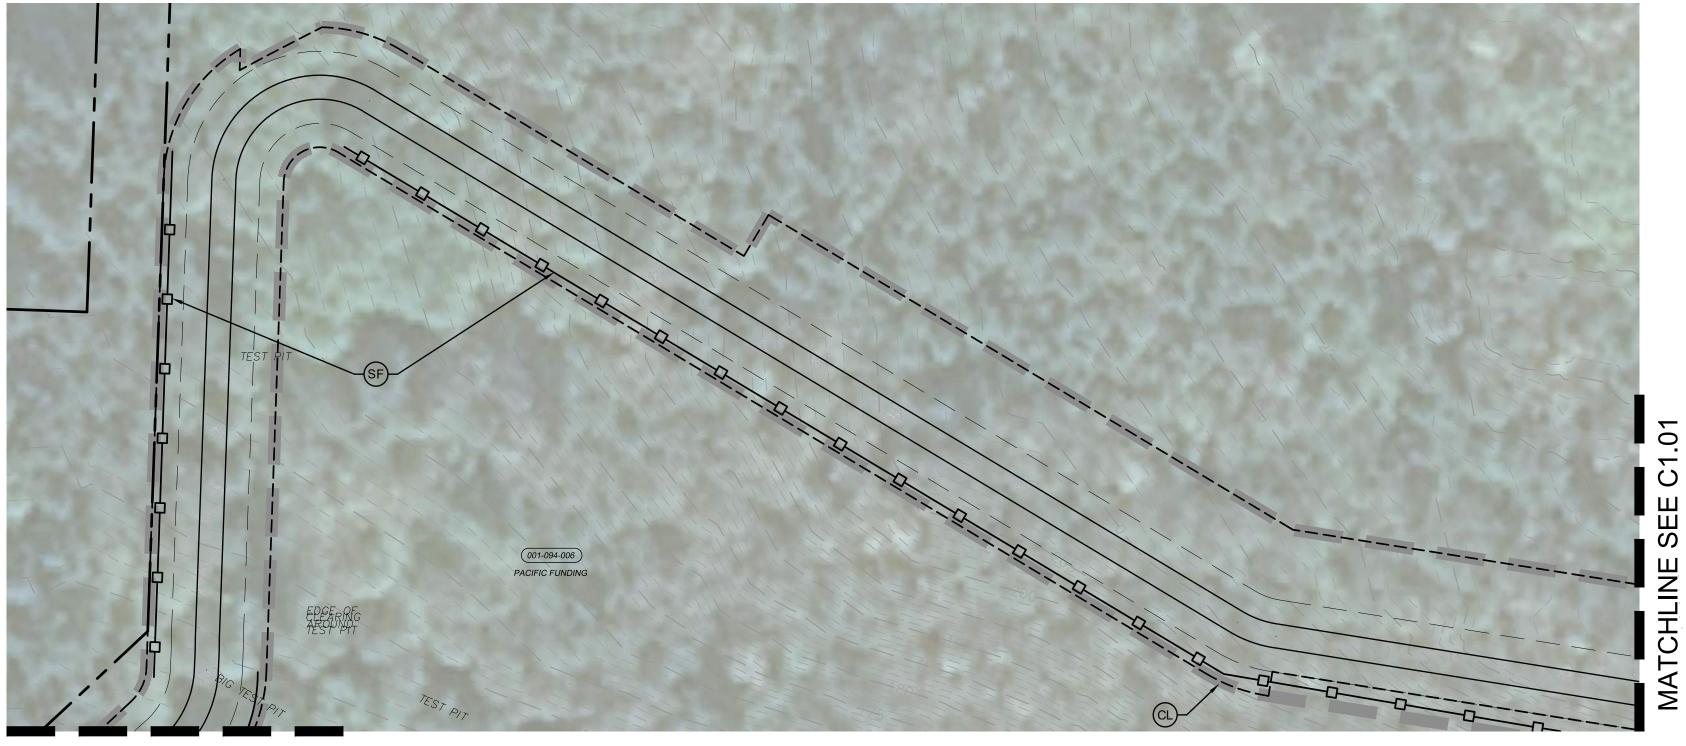
1" = 40 FEET

Designed by: Drawn by:

Sheet No.

C0.03






MATCHLINE SEE LEFT

LEGEND RIGHT-OF-WAY / PROPERTY LINE PERMANENT EASEMENT - EXISTING MINOR CONTOUR — — —XXX— — EXISTING MAJOR CONTOUR CONSTRUCTION ENTRANCE $\frac{2}{(C1.10)}$

CLEARING NOTE

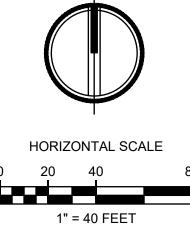EXTENT OF CLEARING /PROJECT LIMITS AND EXACT LOCATION OF SILT FENCE TO BE DETERMINED BY CONTRACTOR BASED ON PROPOSED CONSTRUCTION METHODS, BUT SHALL NOT CROSS THE TEMPORARY EASEMENTS DEPICTED HEREON WITHOUT WRITTEN APPROVAL FROM THE ENGINEER. PAYMENT FOR CLEARING AND GRUBBING SHALL NOT EXCEED BID QUANTITY.







Project Title: **PORT TOWNSEND REGIONAL STORMWATER FACILITY**

CITY OF PORT TOWNSEND

250 MADISON STREET PORT TOWNSEND, WA 98368


WORK ORDER # 8028


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Issue Set & Date:

BID SET

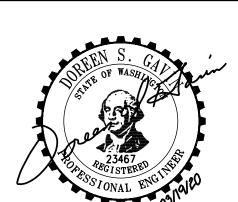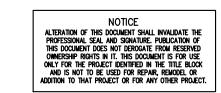03/19/2020





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/ 3\	CHANGE ORDER 04	
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CHANGE ORDER 02

↑ CHANGE ORDER 01 12/17/2020 Revisions:

Sheet Title:

TESC AND DEMOLITION PLAN

Designed by: Drawn by: Checked by:

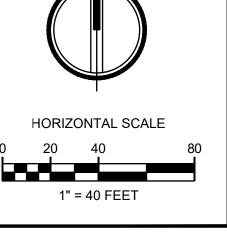
<u>Sheet No.</u>



LEGEND RIGHT-OF-WAY / PROPERTY LINE ———————— TEMPORARY EASEMENT - PERMANENT EASEMENT CLEARING / PROJECT LIMITS EXISTING MINOR CONTOUR — — — XXX— — EXISTING MAJOR CONTOUR

CLEARING NOTE

CLEARING/PROJECT LIMITS AND LOCATION OF SILT FENCE SHOWN IS APPROXIMATE. EXTENT OF CLEARING /PROJECT LIMITS AND EXACT LOCATION OF SILT FENCE TO BE DETERMINED BY CONTRACTOR BASED ON PROPOSED CONSTRUCTION METHODS, BUT SHALL NOT CROSS THE TEMPORARY EASEMENTS DEPICTED HEREON WITHOUT WRITTEN APPROVAL FROM THE ENGINEER. PAYMENT FOR CLEARING AND GRUBBING SHALL NOT EXCEED BID QUANTITY.





PORT TOWNSEND REGIONAL

STORMWATER FACILITY

CITY OF PORT TOWNSEND

250 MADISON STREET PORT TOWNSEND, WA 98368

2160137

WORK ORDER # 8028


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03/19/2020





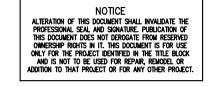CHANGE ORDER 02 03/19/2021

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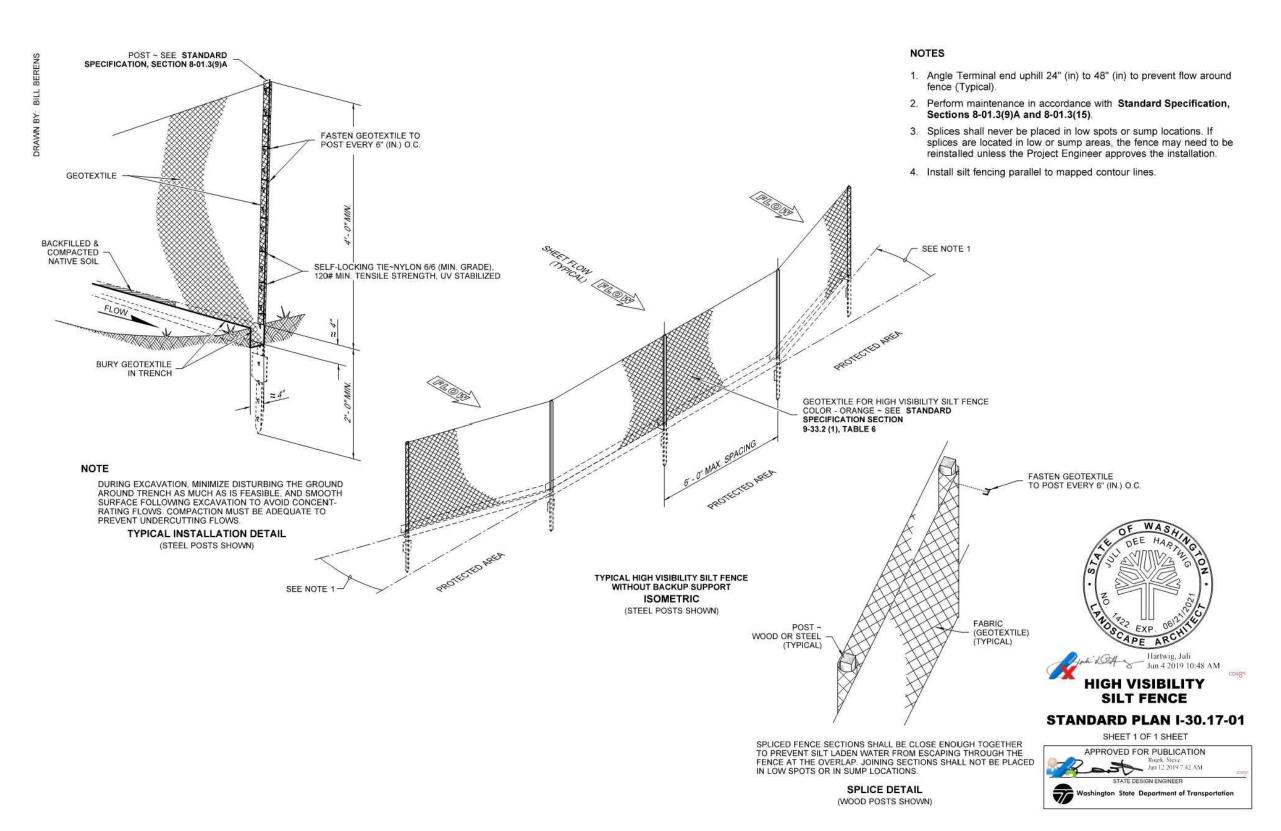
TESC AND DEMOLITION PLAN


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Sheet No.



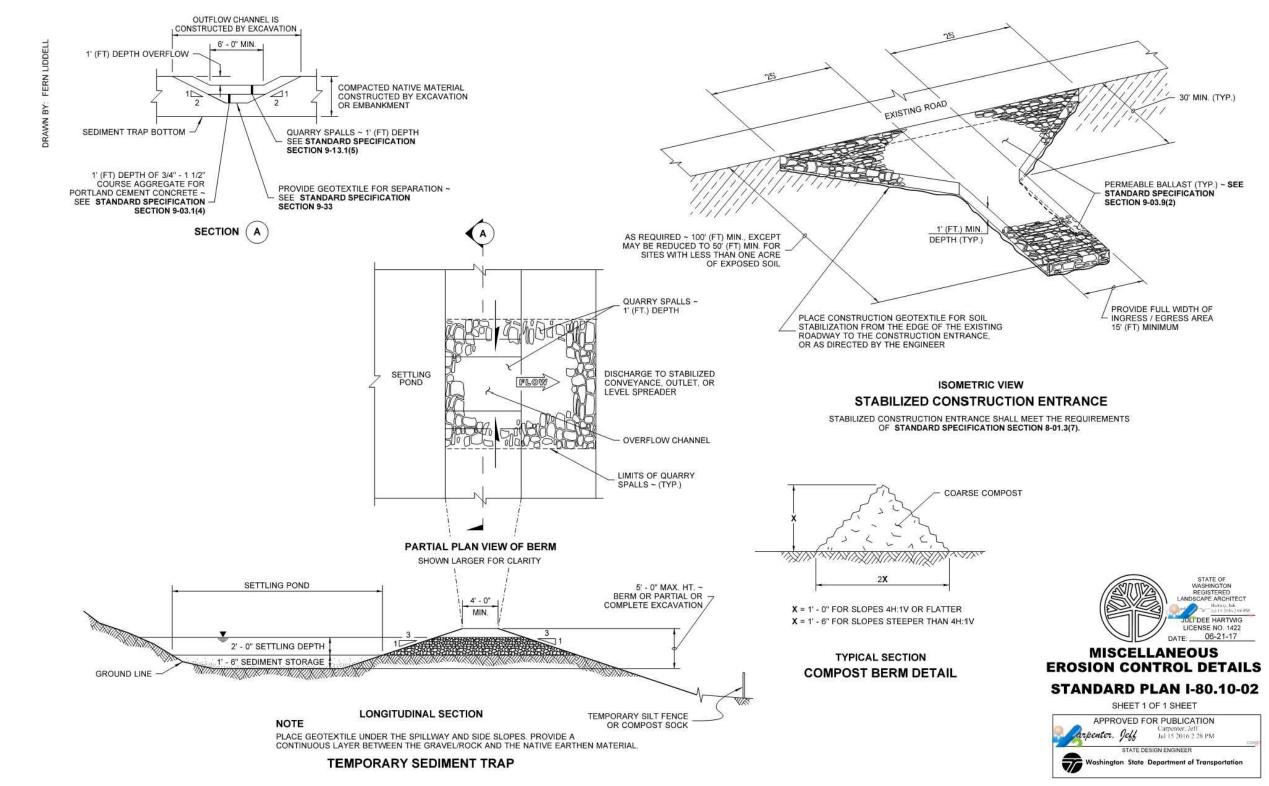CERB CONTRACT NO. 515-790AO-065





SILT FENCE

TESC & DEMOLITION NOTES

- 1. CONTRACTOR TO PRESERVE AND PROTECT ALL EXISTING UTILITES ON PRIVATE PROPERTY AND IN PUBLIC RIGHTS-OF-WAY.
- 2. WHERE POSSIBLE NATURAL VEGETATION WILL BE MAINTAINED FOR SILT CONTROL.
- 3. AS CONSTRUCTION PROGRESSES AND SEASONAL CONDITIONS DICTATE, THE EROSION CONTROL FACILITIES SHALL BE MAINTAINED AND/OR ALTERED AS REQUIRED BY THE CESCL TO ENSURE CONTINUING EROSION/SEDIMENTATION CONTROL.
- 4. TEMPORARY SILTATION PONDS AND ALL TEMPORARY SILTATION CONTROLS SHALL BE MAINTAINED IN A SATISFACTORY CONDITION UNTIL SUCH TIME THAT CLEARING AND/OR CONSTRUCTION IS COMPLETED, PERMANENT DRAINAGE FACILITIES ARE OPERATIONAL, AND THE POTENTIAL FOR EROSION HAS PASSED.
- 5. PUBLIC RIGHTS-OF-WAY SHALL BE KEPT CLEAN. TRACKING OF MUD AND DEBRIS FROM THE SITE WILL NOT BE ALLOWED. FAILURE TO COMPLY WITH THIS CONDITION WILL RESULT IN ALL WORK ON THE SITE BEING STOPPED.

CONSTRUCTION SEQUENCE

1. INSTALL TREE PROTECTION FENCING IN ACCORDANCE WITH APPROVED PLANS.

CONSTRUCTION ENTRANCE

- 2. STAKE AND FLAG CLEARING AND CONSTRUCTION LIMITS. BY CITY SURVEYOR.
- 3. CONSTRUCT CONSTRUCTION ENTRANCE.
- 4. CONSTRUCT ALL TEMPORARY EROSION CONTROL BMP's ACCORDING TO THE PLAN.
- 5. INSPECTION NUMBER 1: EROSION CONTROL, MLA 18-8056 INSPECTION.
- 6. DEMOLISH EXISTING SITE FEATURES INDICATED FOR REMOVAL
- 7. ROUGH GRADE SITE, ALL GRADING SHALL BE DONE IN CONFORMANCE WITH THE PLAN AND THE GEOTECHNICAL ENGINEER'S RECOMMENDATIONS.
- 8. APPLY EROSION CONTROL MULCH AND SEEDING, PLASTIC COVERING, OR EQUAL. ALL DISTURBED LAND AREAS THAT WILL BE LEFT FOR 30 DAYS OR MORE DURING THE PERIOD OF MAY 1 TO OCTOBER 1 SHALL BE IMMEDIATELY SEEDED. IN ADDITION TO SEEDING, SLOPES OF 15% OR GREATER WILL BE MULCHED WITH 2 TONS OF STRAW PER ACRE, OR WITH AN APPROVED EQUAL. DURING THE REST OF THE YEAR, TEMPORARY SOIL STABILIZATION MUST BE APPLIED IMMEDIATELY TO DISTURBED AREAS THAT WILL BE LEFT EXPOSED FOR 7 DAYS OR MORE, AND IMMEDIATELY TO SLOPES GREATER THAN 15% THAT WILL BE LEFT EXPOSED FOR 2 DAYS OR MORE.
- CONSTRUCT UTILITIES AND STORM DRAINAGE FEATURES. INSTALL STORM DRAIN INLET PROTECTION FOR ALL CATCH BASINS W/GRATED LIDS SUBJECT TO ON-SITE AND OFF-SITE
- 10. RELOCATE EROSION CONTROL MEASURES OR INSTALL NEW MEASURES SO THAT AS SITE CONDITIONS CHANGE, THE EROSION AND SEDIMENT CONTROL IS ALWAYS IN ACCORDANCE WITH COUNTY SWPPP MINIMUM REQUIREMENTS.
- 11. FINAL GRADE SITE, CONSTRUCT FINAL SURFACING TREATMENTS. ENSURE SURFACE WATER IS POSITIVELY DRAINED TOWARDS PROPOSED STORMWATER CONTROL FACILITIES.
- 12. INSPECTION NUMBER 2: COMPLETION OF EXCAVATION, FILL, AND EARTHWORK, MLA 18-8056 INSPECTION.
- 13. REMOVE THE REMAINING TEMPORARY EROSION CONTROL ITEMS ONCE SITE HAS BEEN STABILIZED AND UPON APPROVAL.
- 14. COMPLETE FINAL LANDSCAPING AS APPLICABLE.



2215 North 30th Street, Suite 300 Tacoma, WA 98403 253.383.2422 TEL 253.383.2572 FAX www.ahbl.com WEB

Project Title: **PORT TOWNSEND REGIONAL STORMWATER FACILITY**

CITY OF PORT TOWNSEND

250 MADISON STREET PORT TOWNSEND, WA 98368

WORK ORDER #8028

Project No.

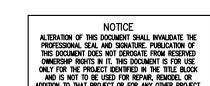
2160137

Issue Set & Date:

BID SET

03/19/2020





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04/21/2021

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 CHANGE ORDER 04

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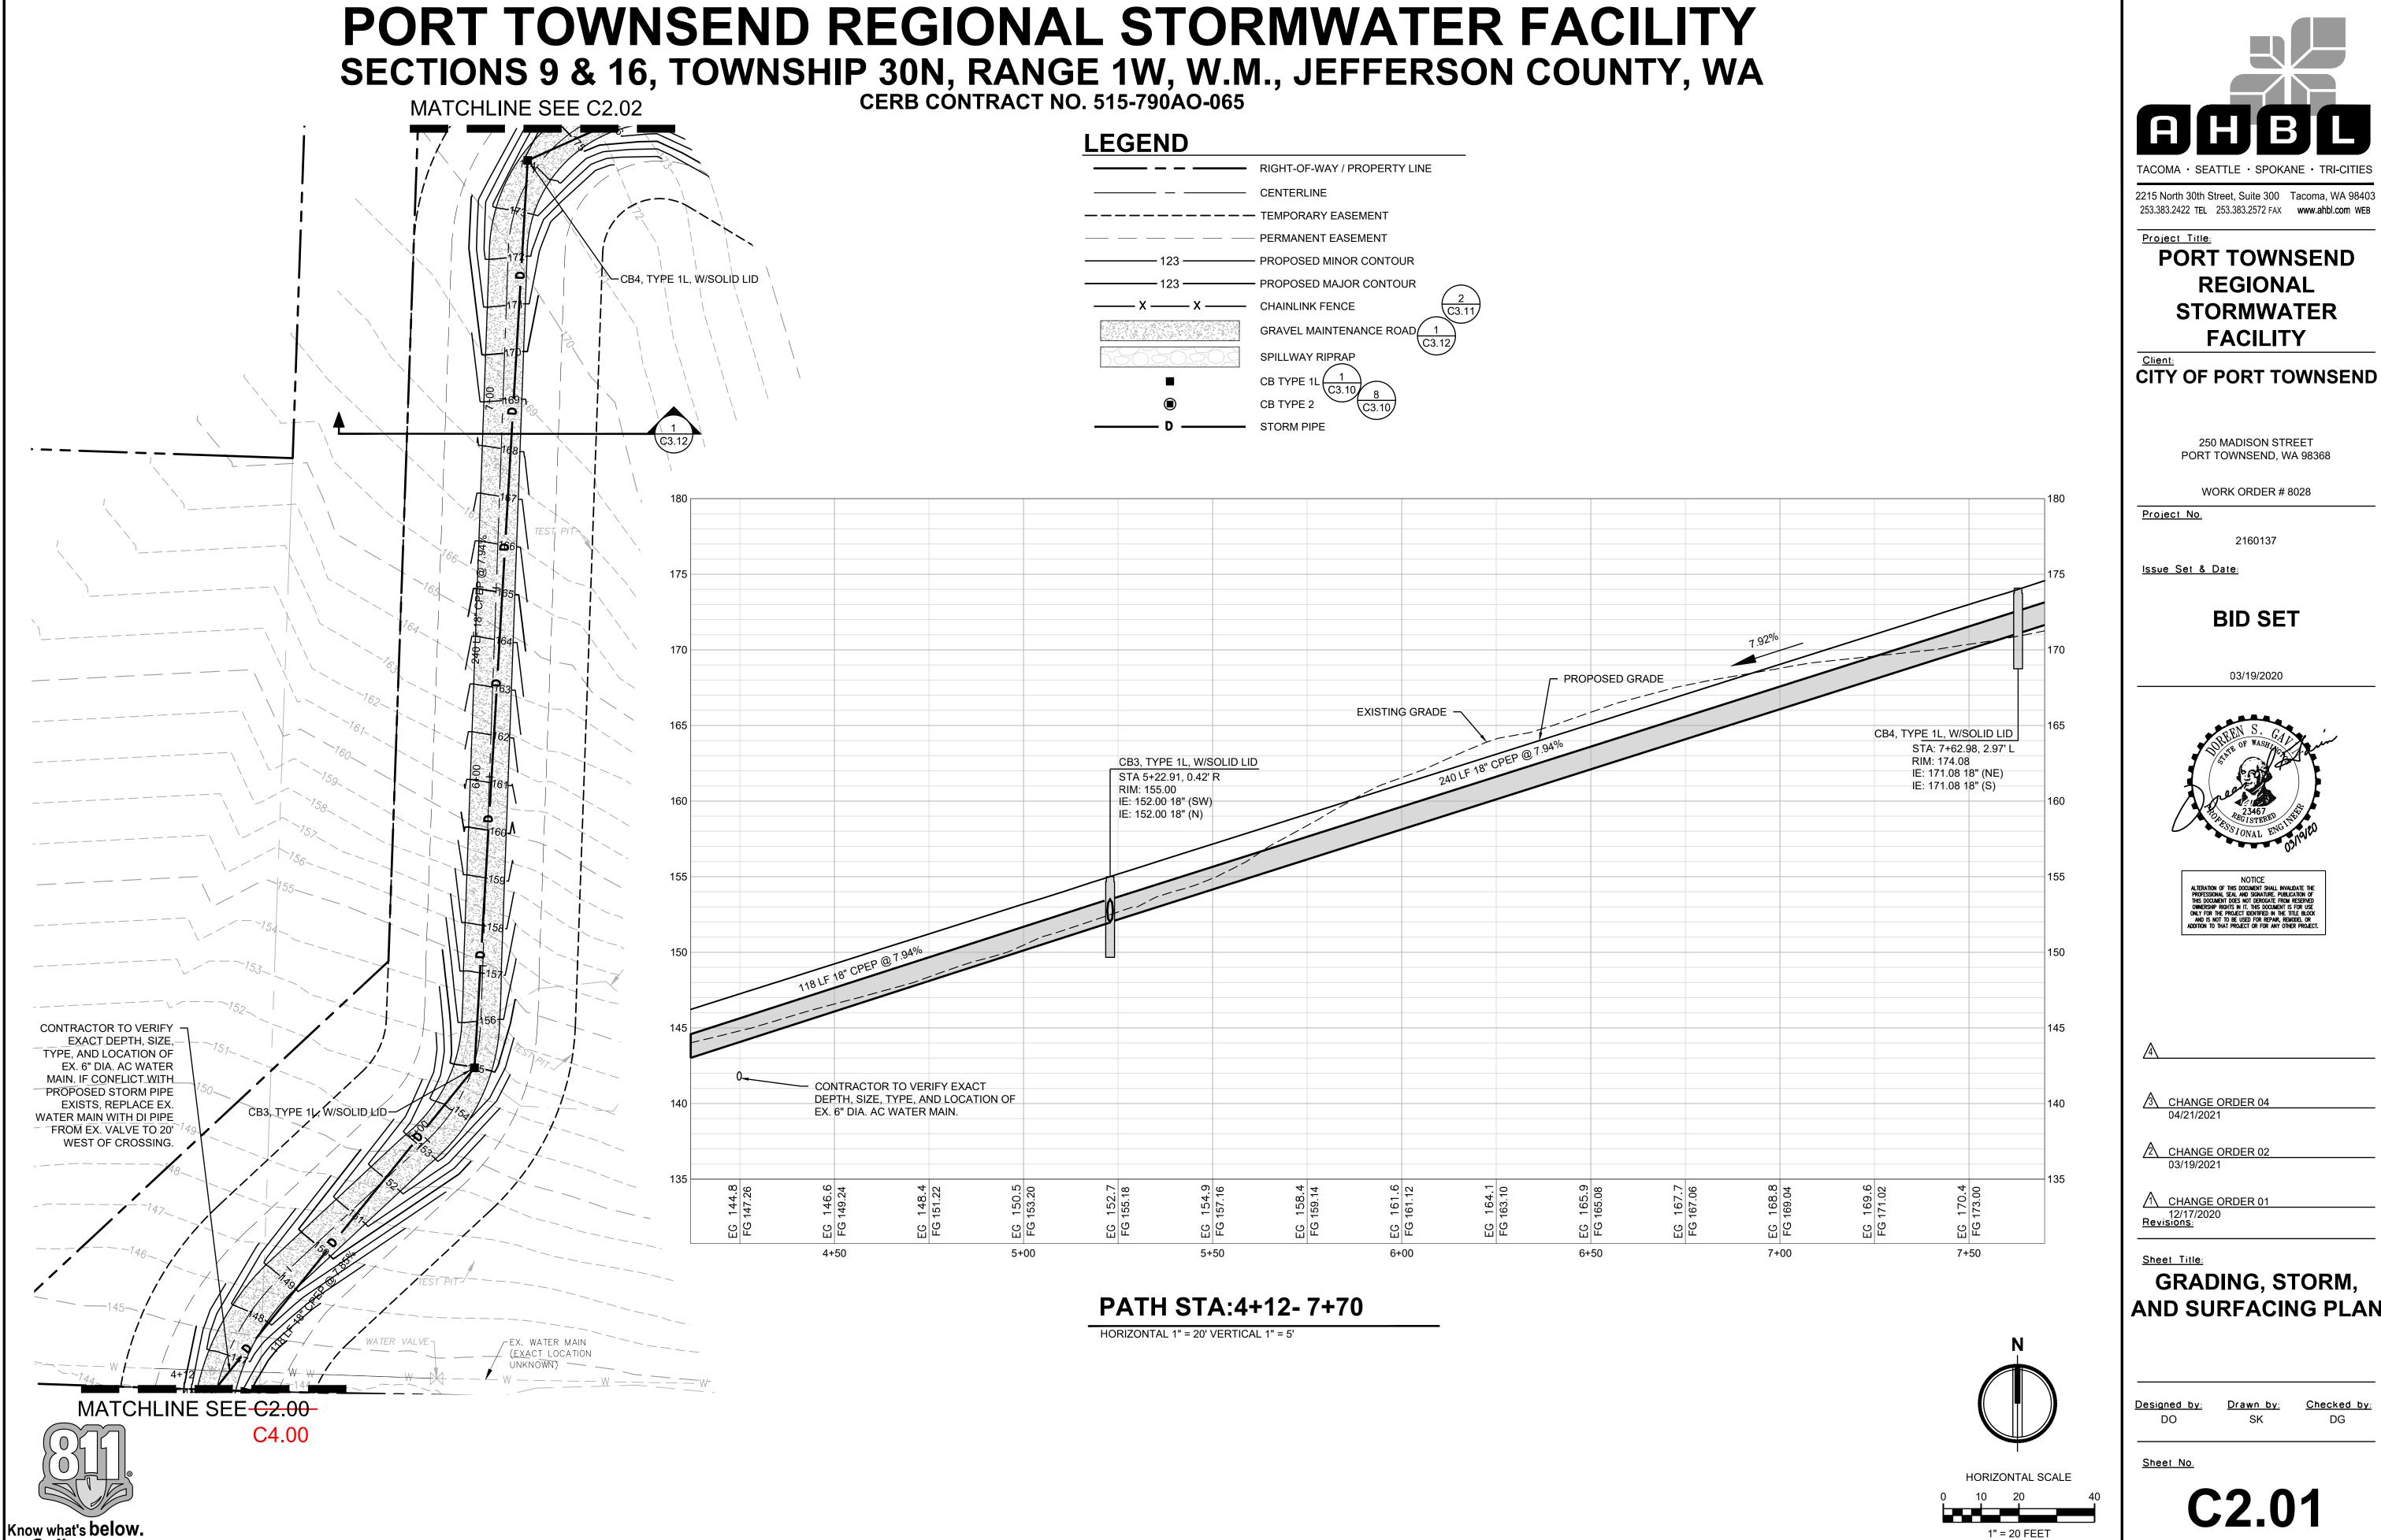
TESC AND DEMOLITION DETAILS AND NOTES

Designed by: Drawn by:

Checked by:

Sheet No.





PORT TOWNSEND, WA 98368 WORK ORDER # 8028 2160137 Issue Set & Date: **BID SET** 03/19/2020

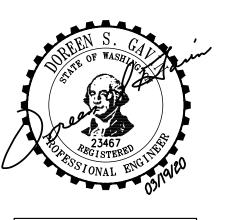
PORT TOWNSEND

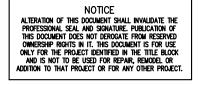
REGIONAL

STORMWATER

FACILITY

250 MADISON STREET





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CHANGE ORDER 04

CHANGE ORDER 02 03/19/2021 ↑ CHANGE ORDER 01

GRADING, STORM, AND SURFACING PLAN

Designed by: Drawn by: Checked by:

Sheet No.

8 of 17 Sheets

Call before you dig.

PORT TOWNSEND REGIONAL STORMWATER FACILITY SECTIONS 9 & 16, TOWNSHIP 30N, RANGE 1W, W.M., JEFFERSON COUNTY, WA **LEGEND** RIGHT-OF-WAY / PROPERTY LINE GRAVEL MAINTENANCE ROAD(MATCHLINE SEE C2.01 EXISTING GRADE

CB5, TYPE 1L, W/SOLID LID STA: 8+06 3.40' L RIM: 177.47 IE IN: 174.47 (18"SE) IE OUT: 174.47 (18"SW) HORIZONTAL SCALE EG FG 1" = 20 FEET

PATH STA:7+70 - 11+00

HORIZONTAL 1" = 20' VERTICAL 1" = 5'



PORT TOWNSEND REGIONAL STORMWATER FACILITY

CITY OF PORT TOWNSEND

250 MADISON STREET

PORT TOWNSEND, WA 98368

WORK ORDER # 8028

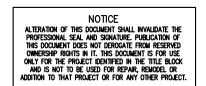
2160137

Project No.

Issue Set & Date:

BID SET





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CHANGE ORDER 04

2 CHANGE ORDER 02 03/19/2021

↑ CHANGE ORDER 01 12/17/2020 Revisions:

Sheet Title:

GRADING, STORM, AND SURFACING PLAN

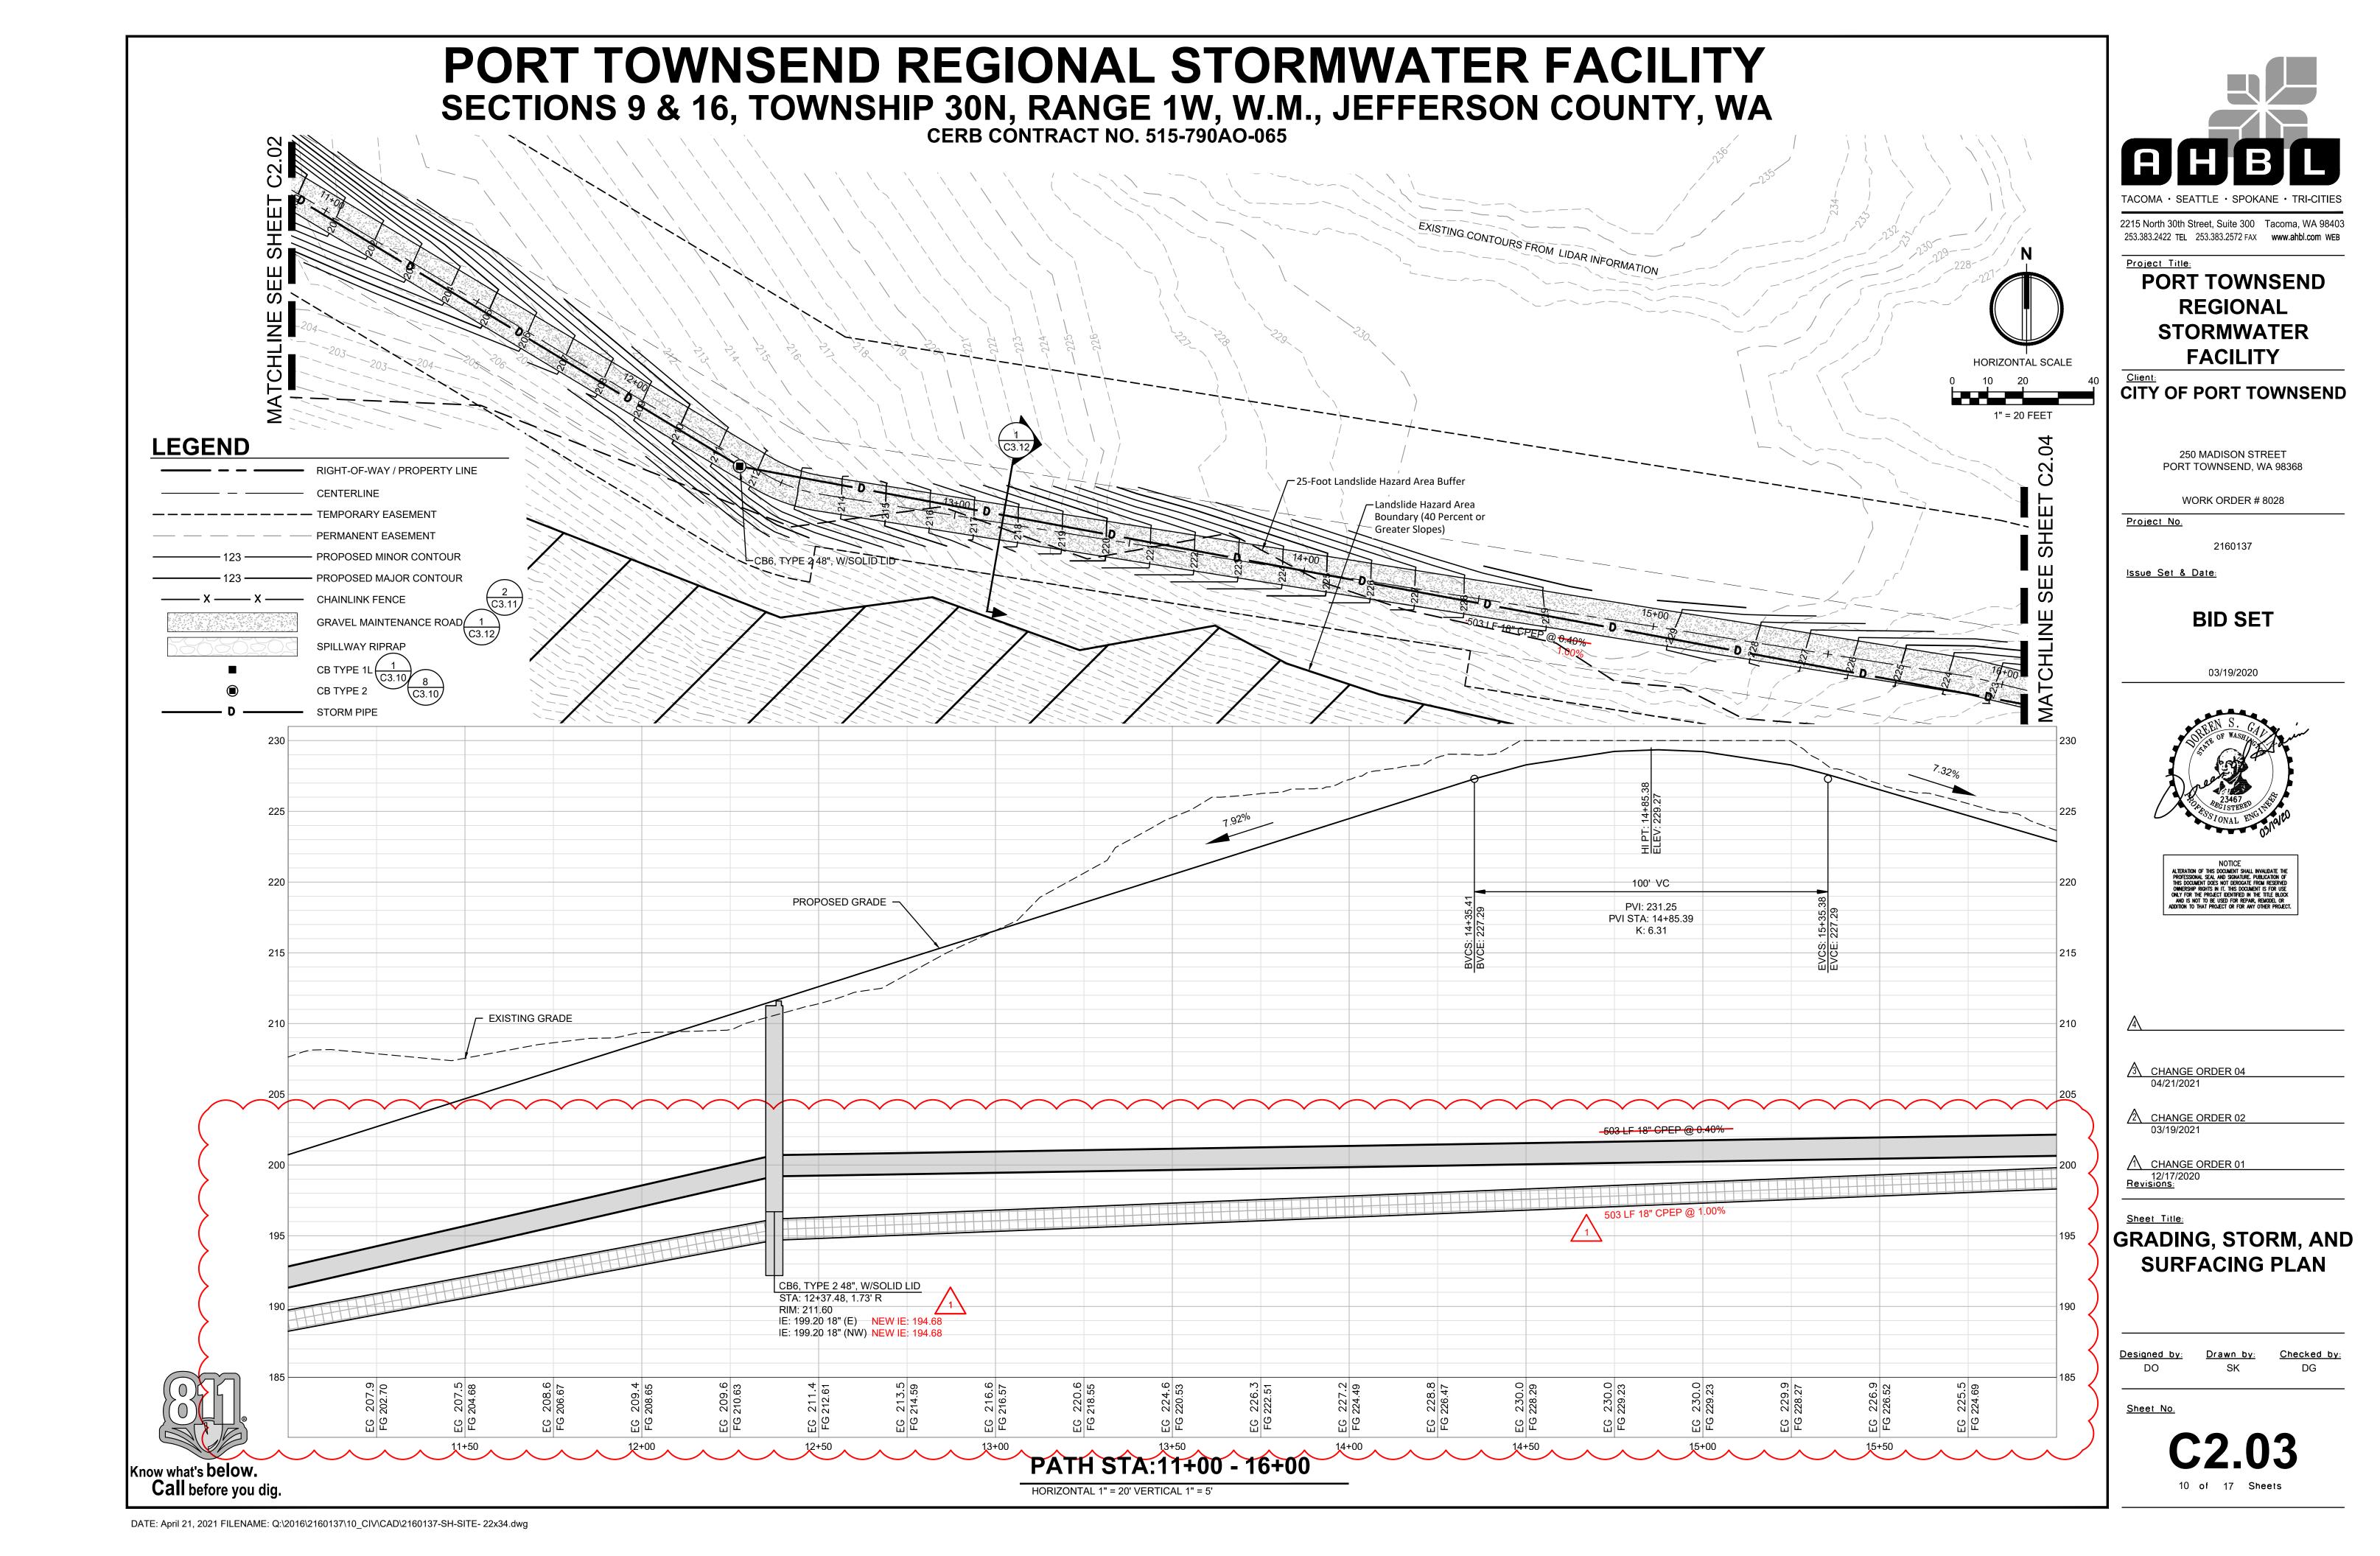
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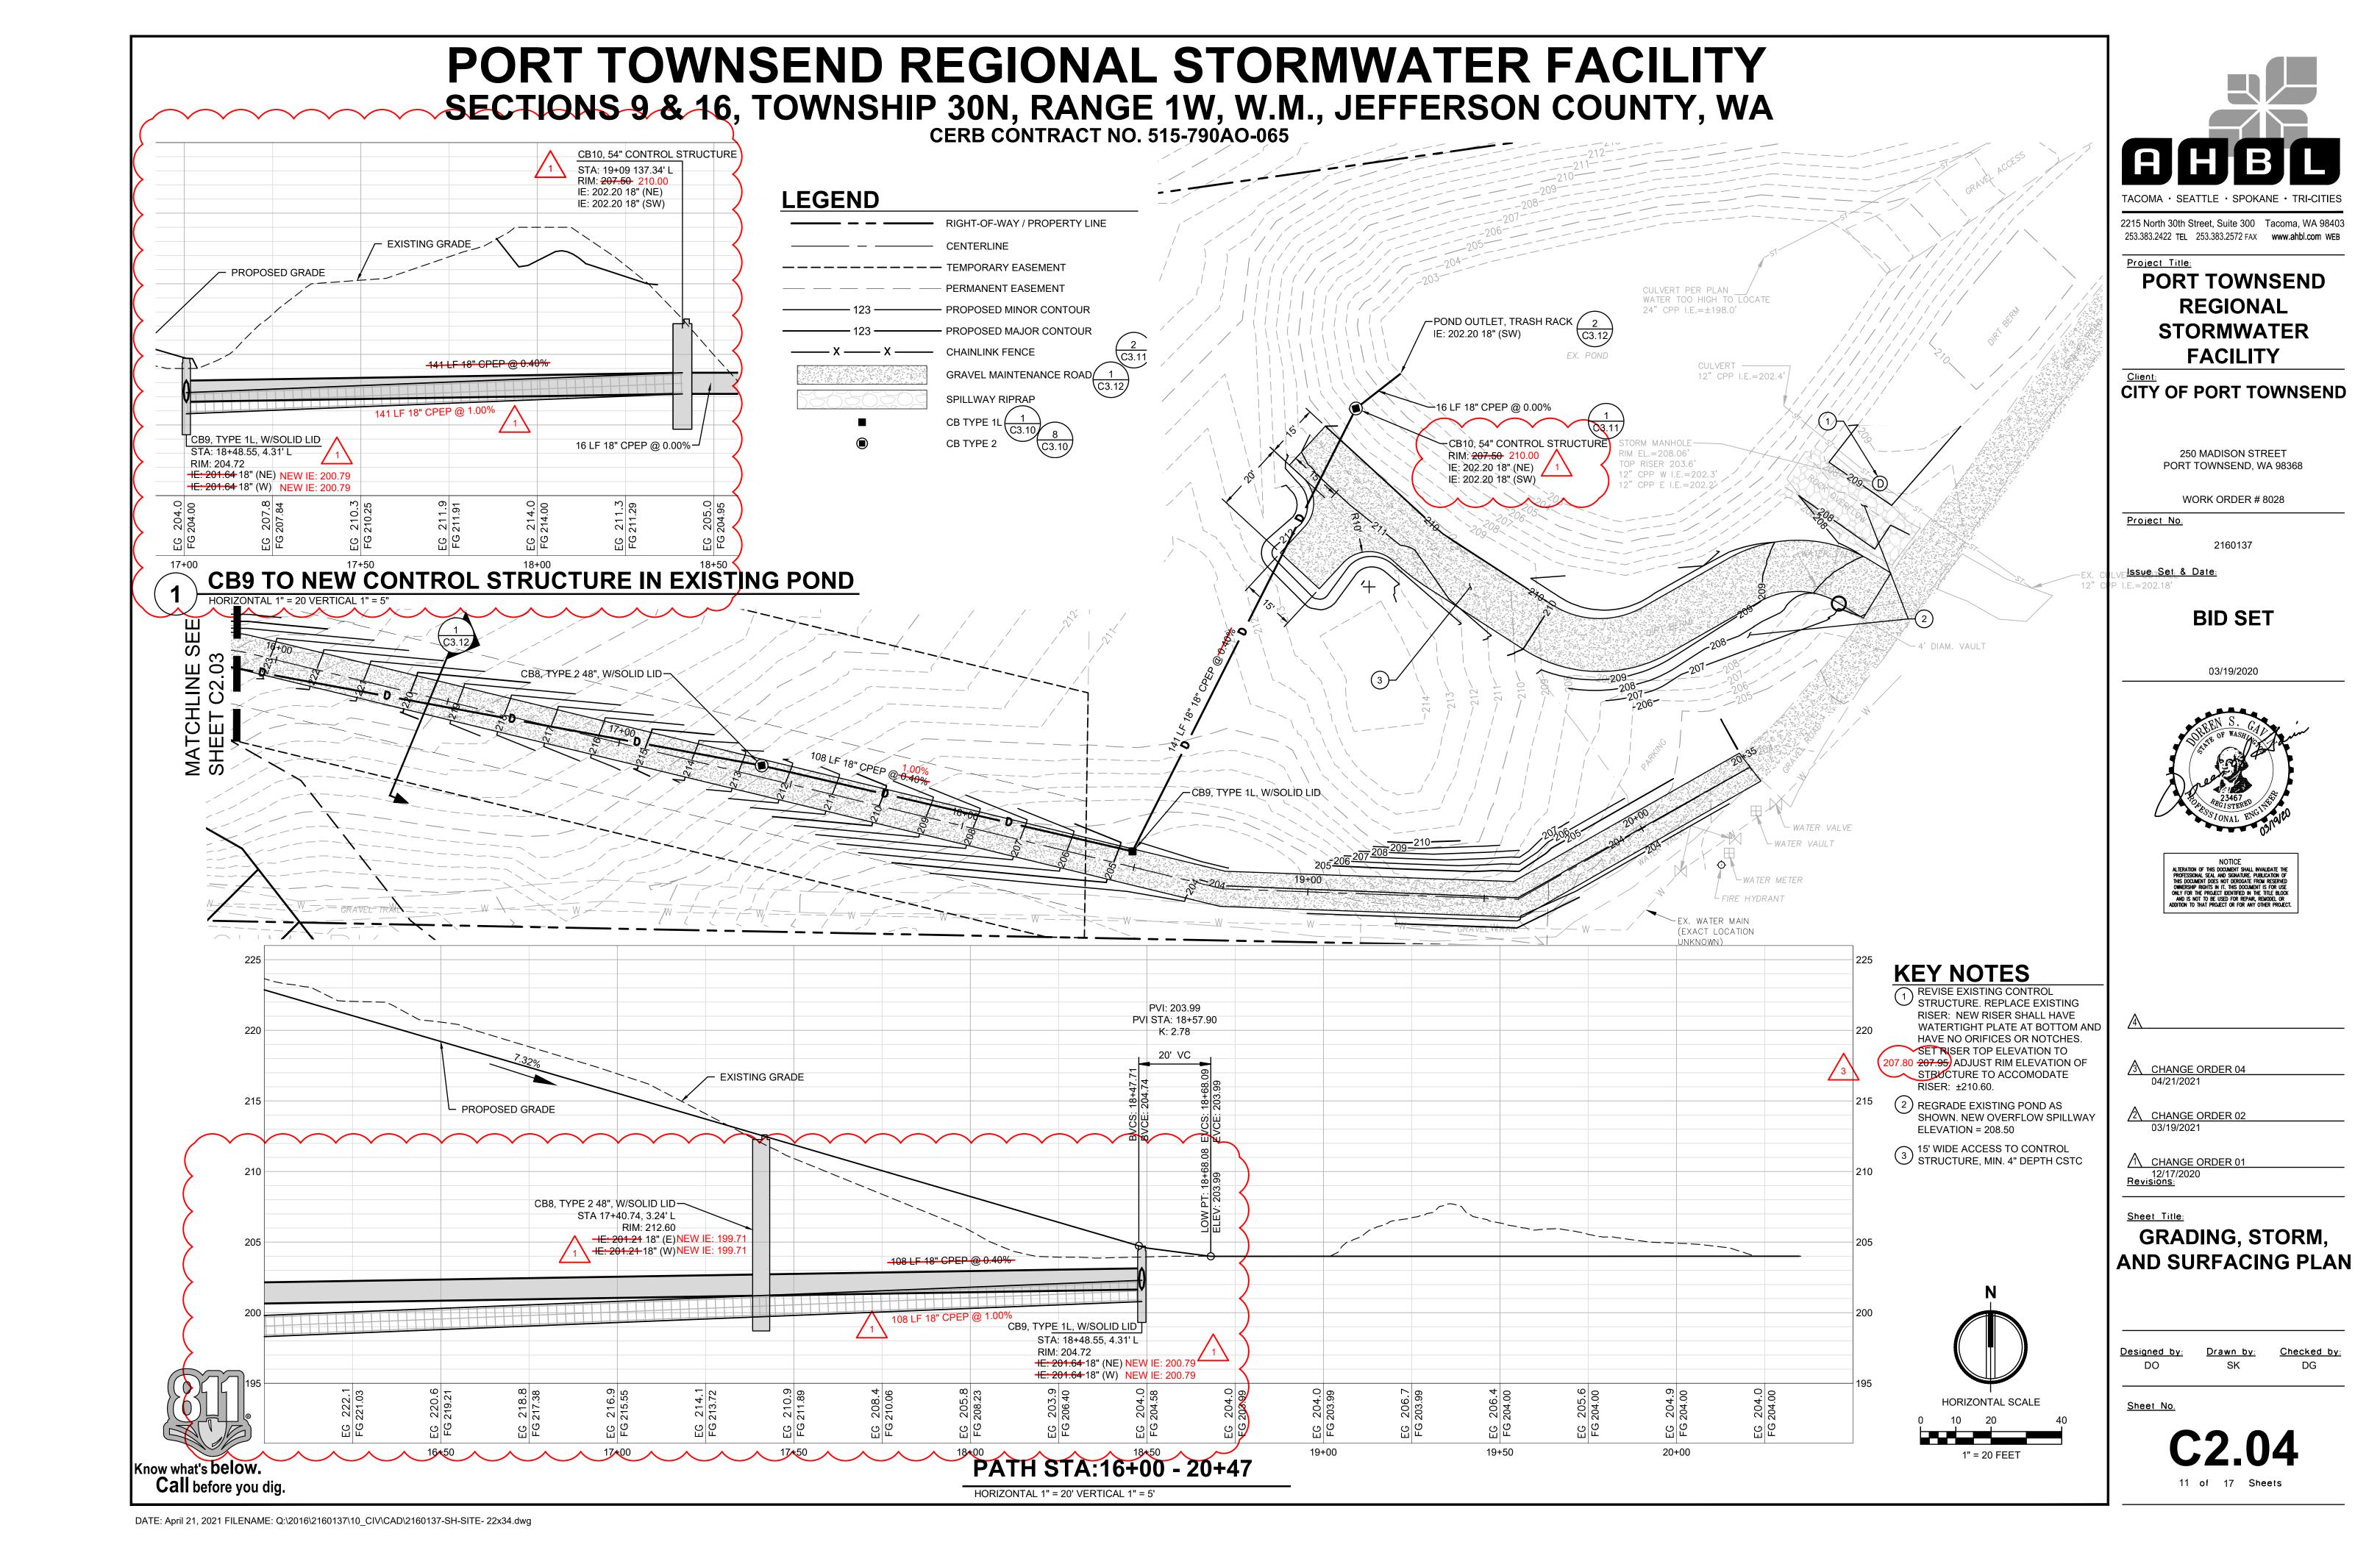
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9 of 17 Sheets


Know what's below.

Call before you dig.





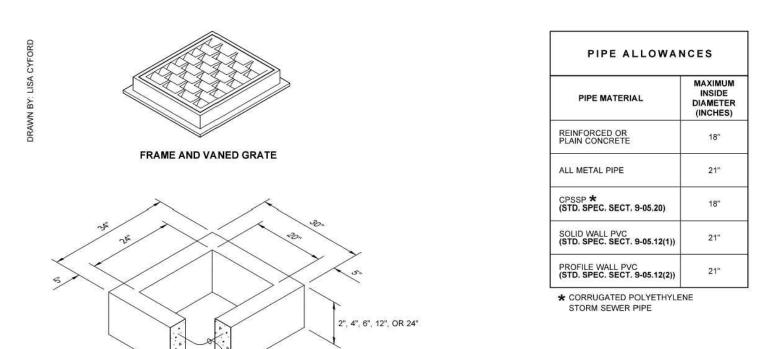CERB CONTRACT NO. 515-790AO-065



ONE #3 BAR FOR EACH 6" (IN) HEIGHT INCREMENT, SPACED EQUALLY

RECTANGULAR ADJUSTMENT SECTION

REDUCING SECTION

CB TYPE 1L


1. As acceptable alternatives to the rebar shown in the PRECAST BASE SECTION, fibers (placed according to the Standard Specifications), or wire mesh having a minimum area of 0.12 square inches per foot, shall be used with the minimum required rebar shown in the ALTERNATIVE PRECAST BASE SECTION. Wire mesh shall not be placed in the


- 2. The knockout shall not be greater than 26" (in), in any direction. Knockouts shall have a wall thickness of 2" (in) minimum to 2.5" (in) maximum. Provide a 1.5" (in) minimum gap between the knockout wall and the outside of the pipe. After the pipe is installed, fill the gap with joint mortar in accordance with Standard Specification Section 9-04.3.
- 3. The maximum depth from the finished grade to the lowest pipe invert
- 4. The frame and grate may be installed with the flange down or integrally cast into the adjustment section with flange up.
- 5. The Precast Base Section may have a rounded floor, and the walls may
- be sloped at a rate of 1: 24 or steeper. 6. The opening shall be measured at the top of the Precast Base Section.

#3 BAR HOOP

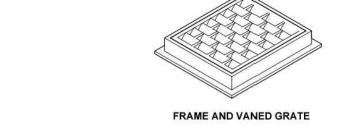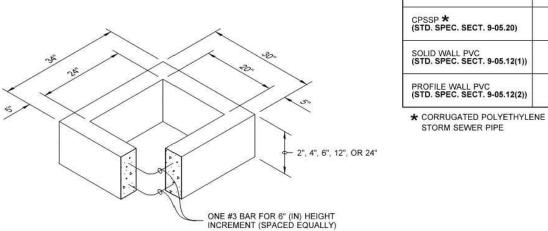ALTERNATIVE PRECAST BASE SECTION

7. All pickup holes shall be grouted full after the basin has been placed.





RECTANGULAR ADJUSTMENT SECTION

1.	As acceptable alternatives to the rebar shown in the PRECAST BASE
	SECTION , fibers (placed according to the Standard Specifications), or wire mesh having a minimum area of 0.12 square inches per foot shall
	be used with the minimum required rebar shown in the ALTERNATIVE
	PRECAST BASE SECTION. Wire mesh shall not be placed in the knockouts.

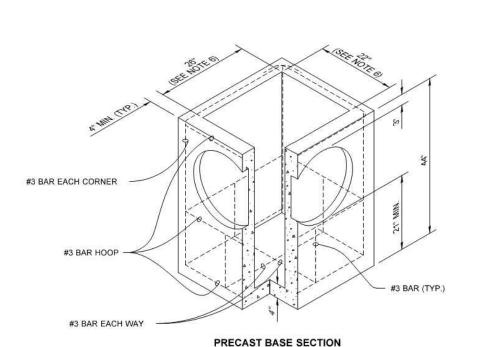
- 2. The knockout diameter shall not be greater than 20" (in). Knockouts shall have a wall thickness of 2" (in) minimum to 2.5" (in) maximum. Provide a 1.5" (in) minimum gap between the knockout wall and the outside of the pipe. After the pipe is installed, fill the gap with joint mortar in accordance with Standard Specification Section 9-04.3.
- 3. The maximum depth from the finished grade to the lowest pipe invert
- 4. The frame and grate may be installed with the flange down, or integrally cast into the adjustment section with flange up.
- 5. The Precast Base Section may have a rounded floor, and the walls may be sloped at a rate of 1: 24 or steeper.

1. No steps are required when height is 4' or less.


2. The bottom of the precast catch basin may be sloped to facilitate cleaning

3. The rectangular frame and grate may be installed with the flange up or down.

- 6. The opening shall be measured at the top of the Precast Base Section.
- 7. All pickup holes shall be grouted full after the basin has been placed.



CB TYPE 1

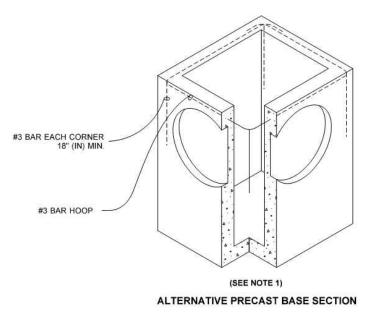

PIPE ALLOWANCES

(INCHES)

PIPE MATERIAL

REINFORCED OR PLAIN CONCRETE

ALL METAL PIPE

CPSSP *
(STD. SPEC. SECT. 9-05.20)

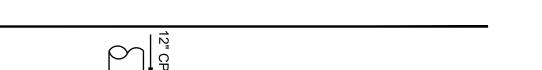
SOLID WALL PVC (STD. SPEC. SECT. 9-05.12(1))

PROFILE WALL PVC (STD. SPEC. SECT. 9-05.12(2))

STORM SEWER PIPE



STANDARD PLAN B-5.20-02 SHEET 1 OF 1 SHEET




CATCH BASIN TYPE 1L

STANDARD PLAN B-5.40-02


APPROVED FOR PUBLICATION Carpenter, Jeff Jan 26 2017 6:49 AM

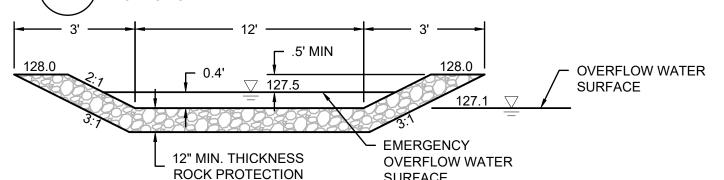
SHEET 1 OF 1 SHEET





PRECAST BASE SECTION

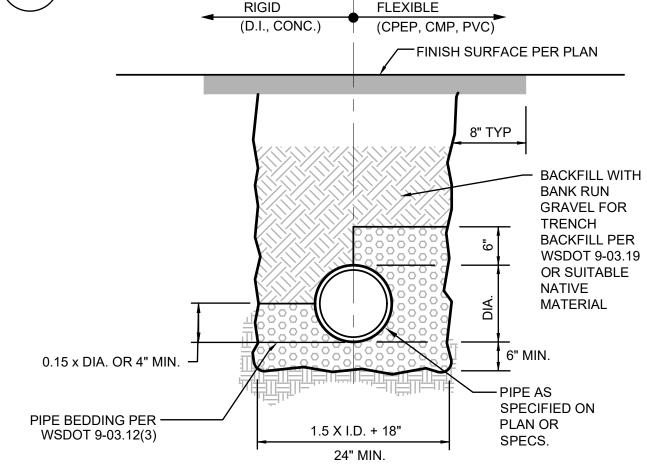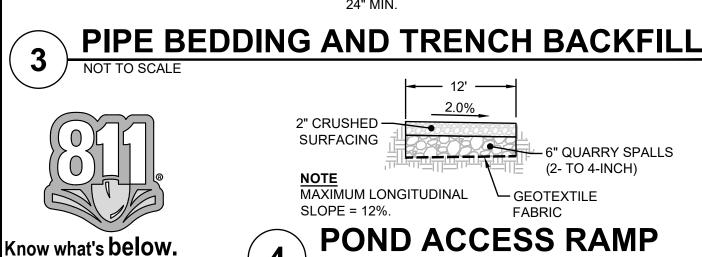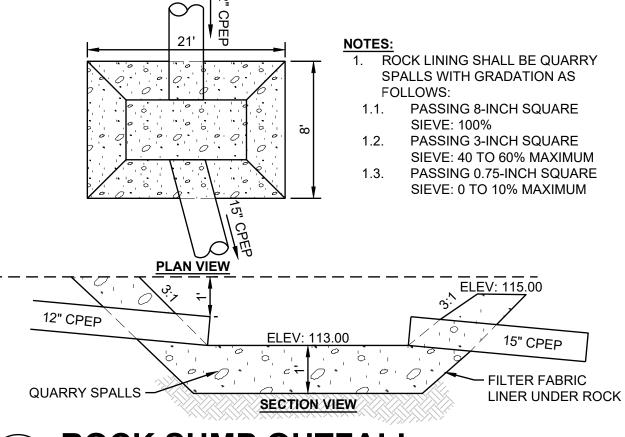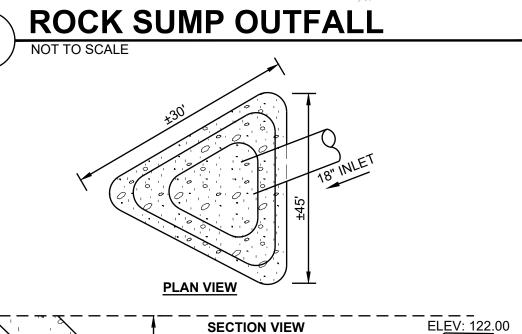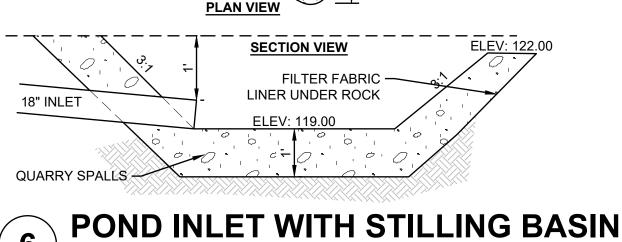
EMERGENCY OVERFLOW SPILLWAY

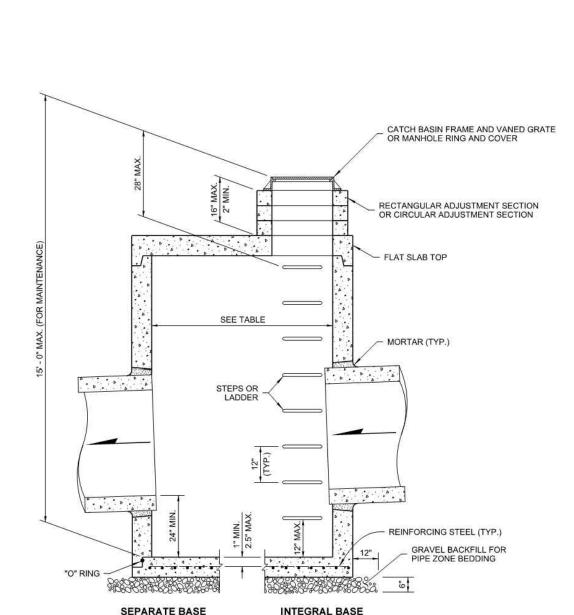


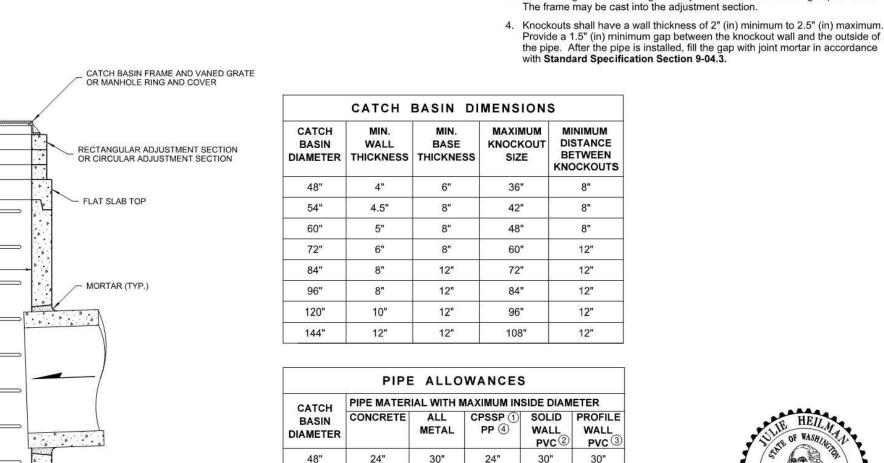













CATCH	PIPE MATERIAL WITH MAXIMUM INSIDE DIAMETER						
BASIN DIAMETER	CONCRETE	ALL METAL	CPSSP ① PP ④	SOLID WALL PVC ²	PROFILE WALL PVC 3		
48"	24"	30"	24"	30"	30"		
54"	30"	36"	30"	36"	36"		
60"	36"	42"	36"	42"	42"		
72"	42"	54"	42"	48"	48"		
84"	54"	60"	54"	48"	48"		
96"	60"	72"	60"	48"	48"		
120"	66"	84"	60"	48"	48"		
144"	78"	96"	60"	48"	48"		

① Corrugated Polyethylene Storm Sewer Pipe (See Standard Specification Section 9-05.20) ② (See Standard Specification Section 9-05.12(1)) ③ (See Standard Specification Section 9-05.12(2)) 4 Polypropylene Pipe (See Standard Specification Section 9-05.24)



STANDARD PLAN B-10.20-02 SHEET 1 OF 1 SHEET APPROVED FOR PUBLICATION Carpenter, Jeff Mar 2 2018 10 01 AM STATE DESIGN ENGINEER

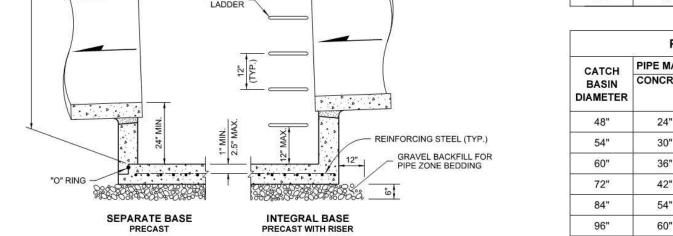Washington State Department of Transportation



CB TYPE 2

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PORT TOWNSEND REGIONAL STORMWATER FACILITY

CITY OF PORT TOWNSEND

250 MADISON STREET PORT TOWNSEND. WA 98368

2160137

WORK ORDER # 8028

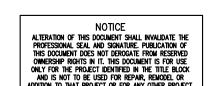
Project No.

Issue Set & Date:

BID SET

03/19/2020





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/3\ CHANGE ORDER 04

 CHANGE ORDER 02

 03/19/2021

/1\ CHANGE ORDER 01 12/17/2020 Revisions:

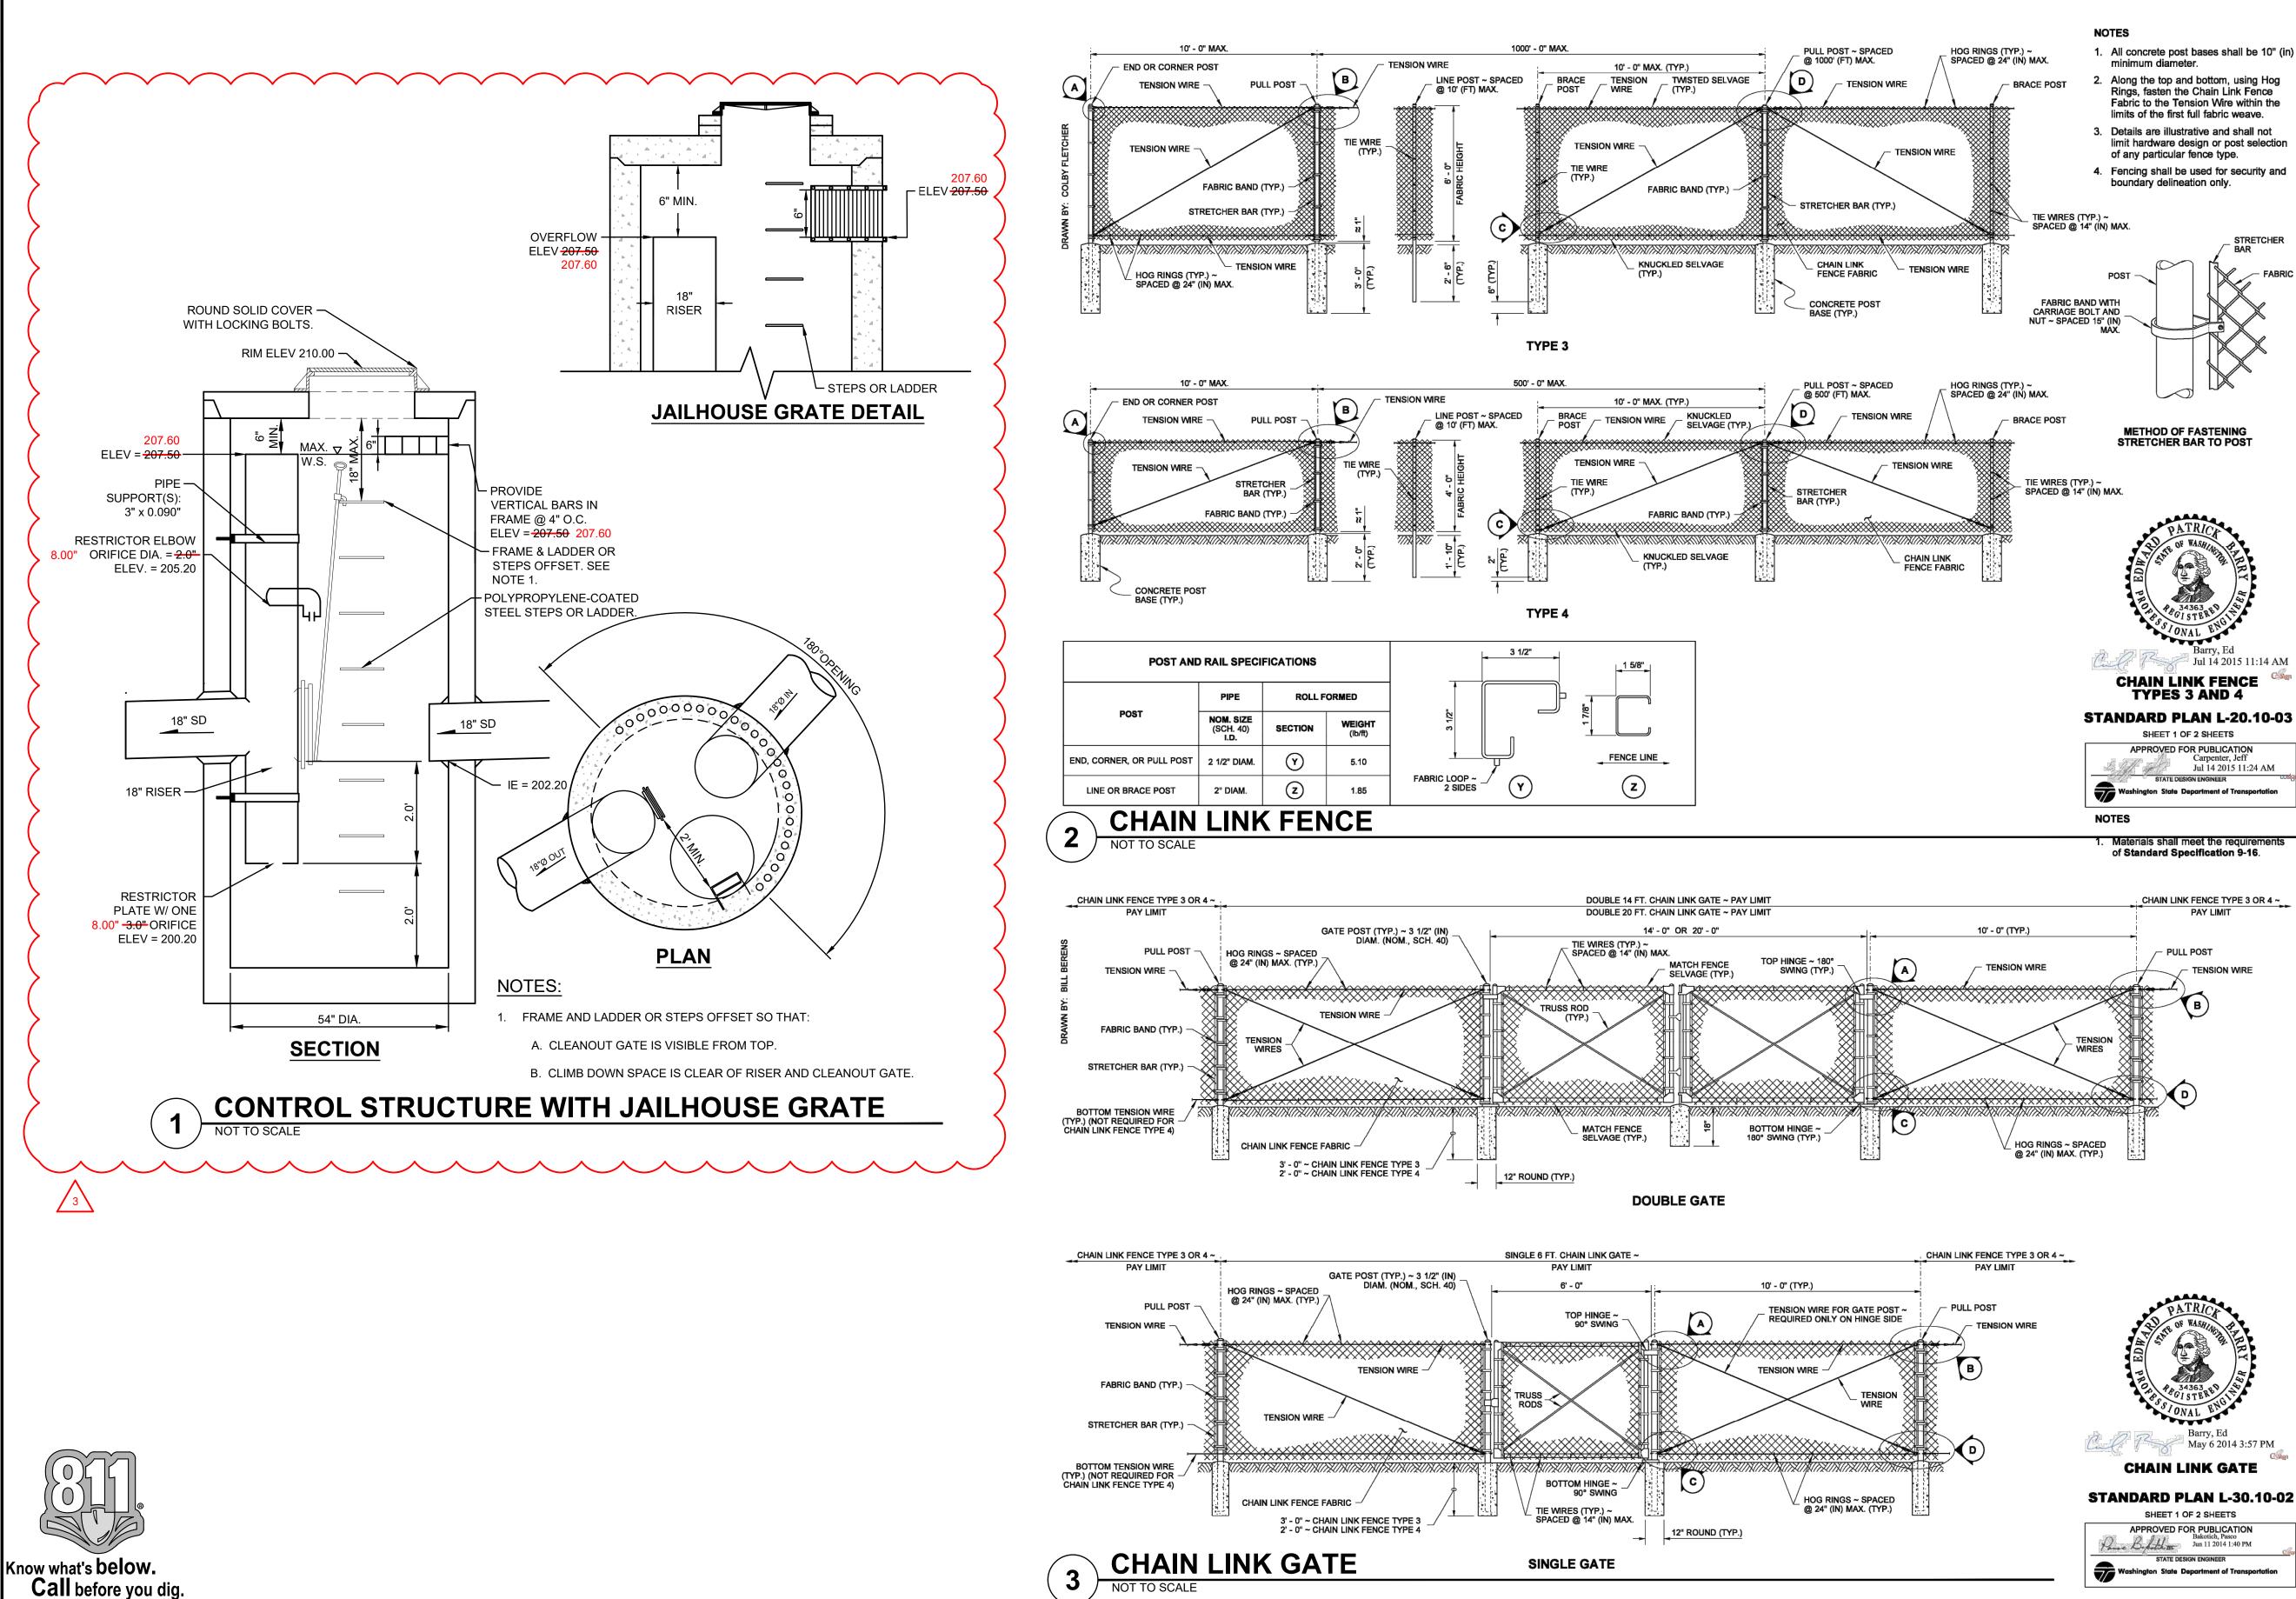
Sheet Title:

STORM DRAINAGE **DETAILS**

Checked by: <u>Drawn by:</u>

Sheet No.

CERB CONTRACT NO. 515-790AO-065





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Project Title: **PORT TOWNSEND REGIONAL STORMWATER FACILITY**

CITY OF PORT TOWNSEND

250 MADISON STREET PORT TOWNSEND, WA 98368

WORK ORDER # 8028

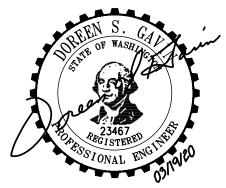
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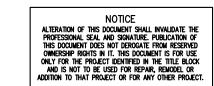
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 CHANGE ORDER 04

 CHANGE ORDER 02

 03/19/2021

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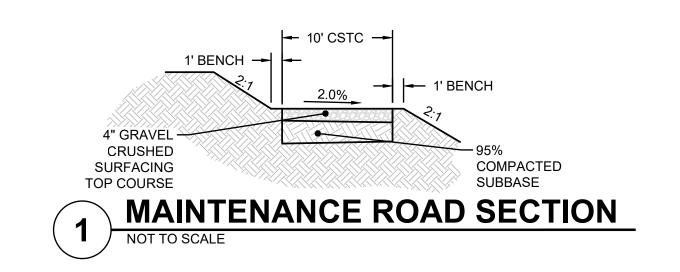
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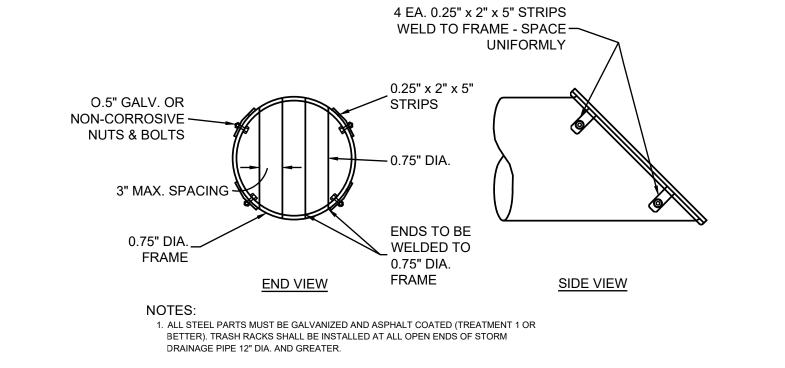
STORM DRAINAGE **DETAILS**

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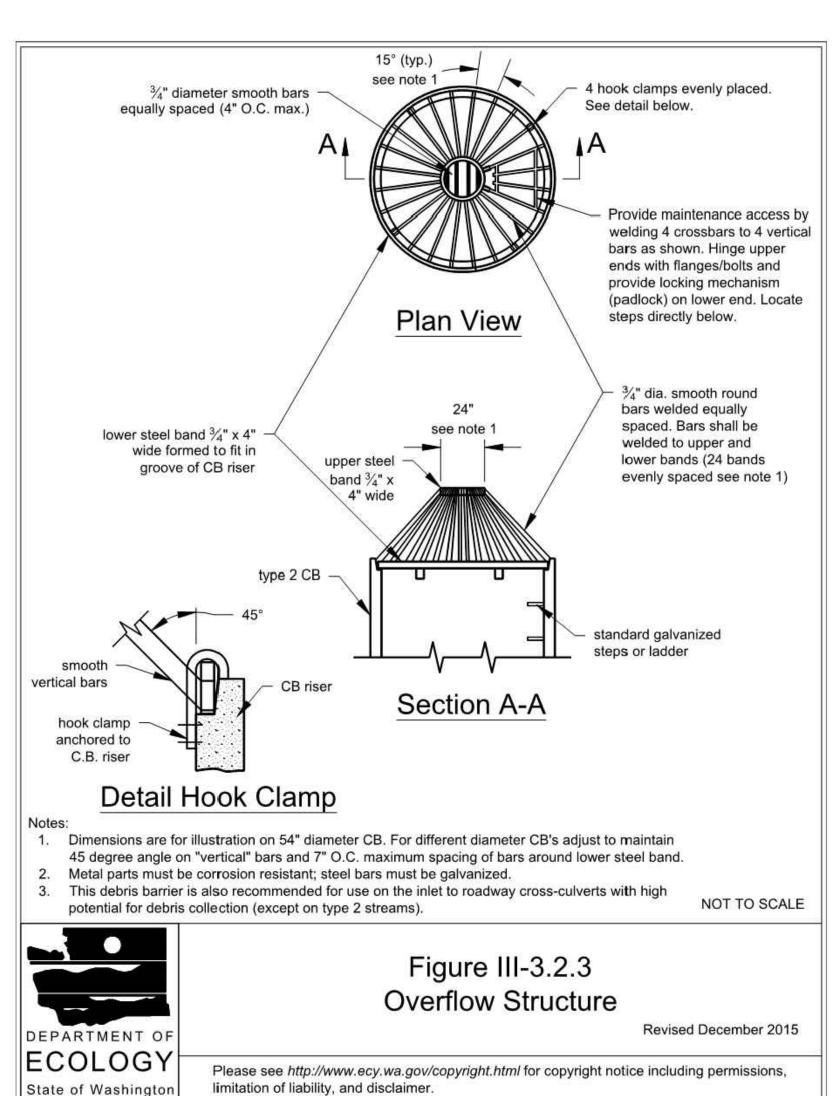
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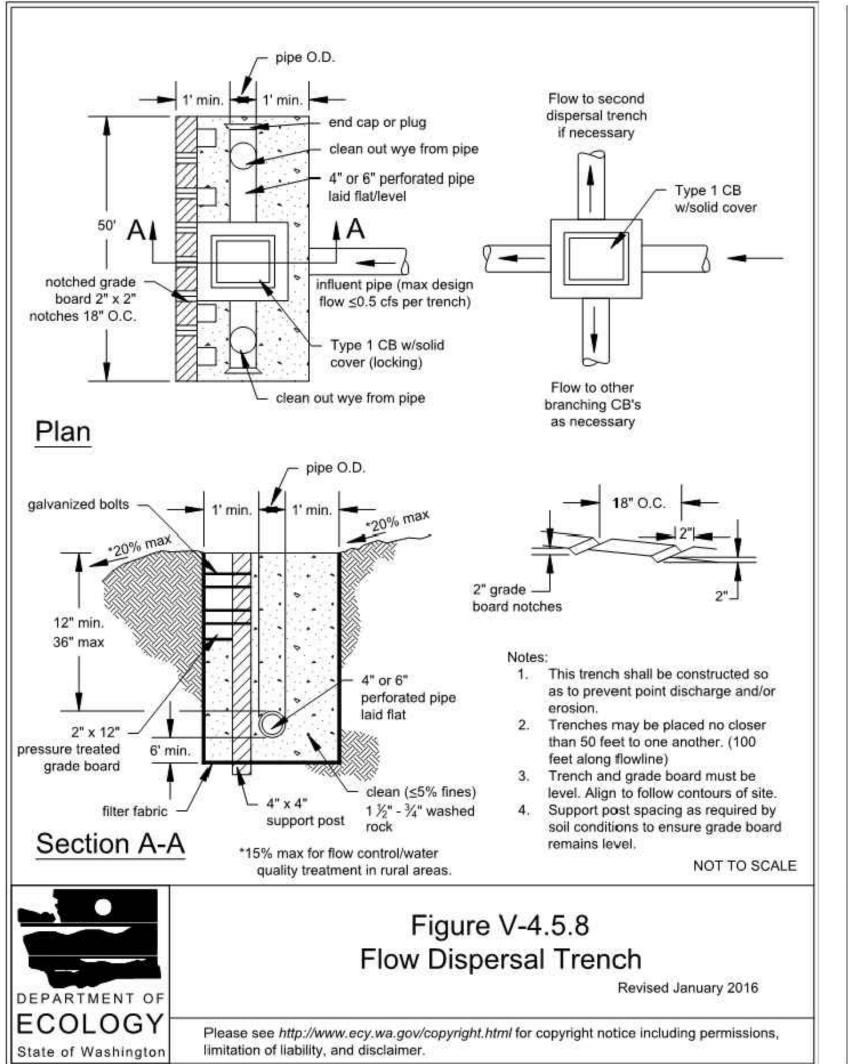
CERB CONTRACT NO. 515-790AO-065

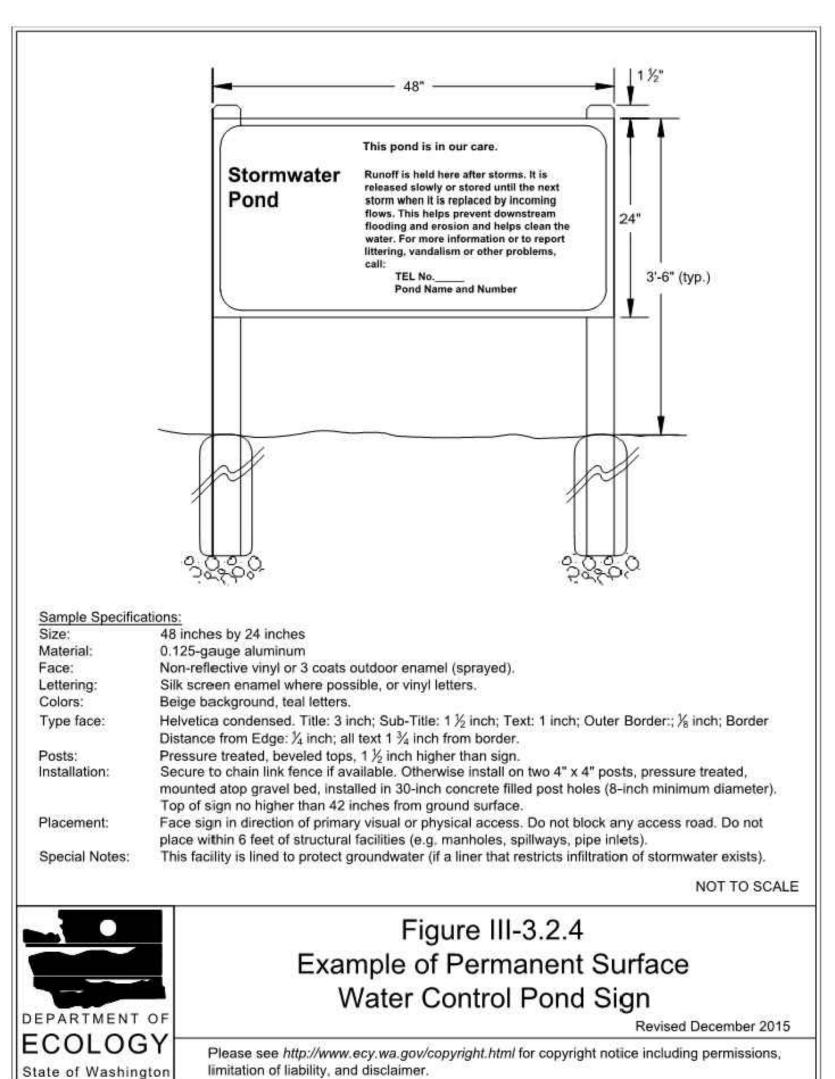














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CITY OF PORT TOWNSEND

250 MADISON STREET PORT TOWNSEND, WA 98368

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Project No.

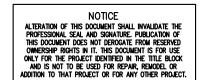
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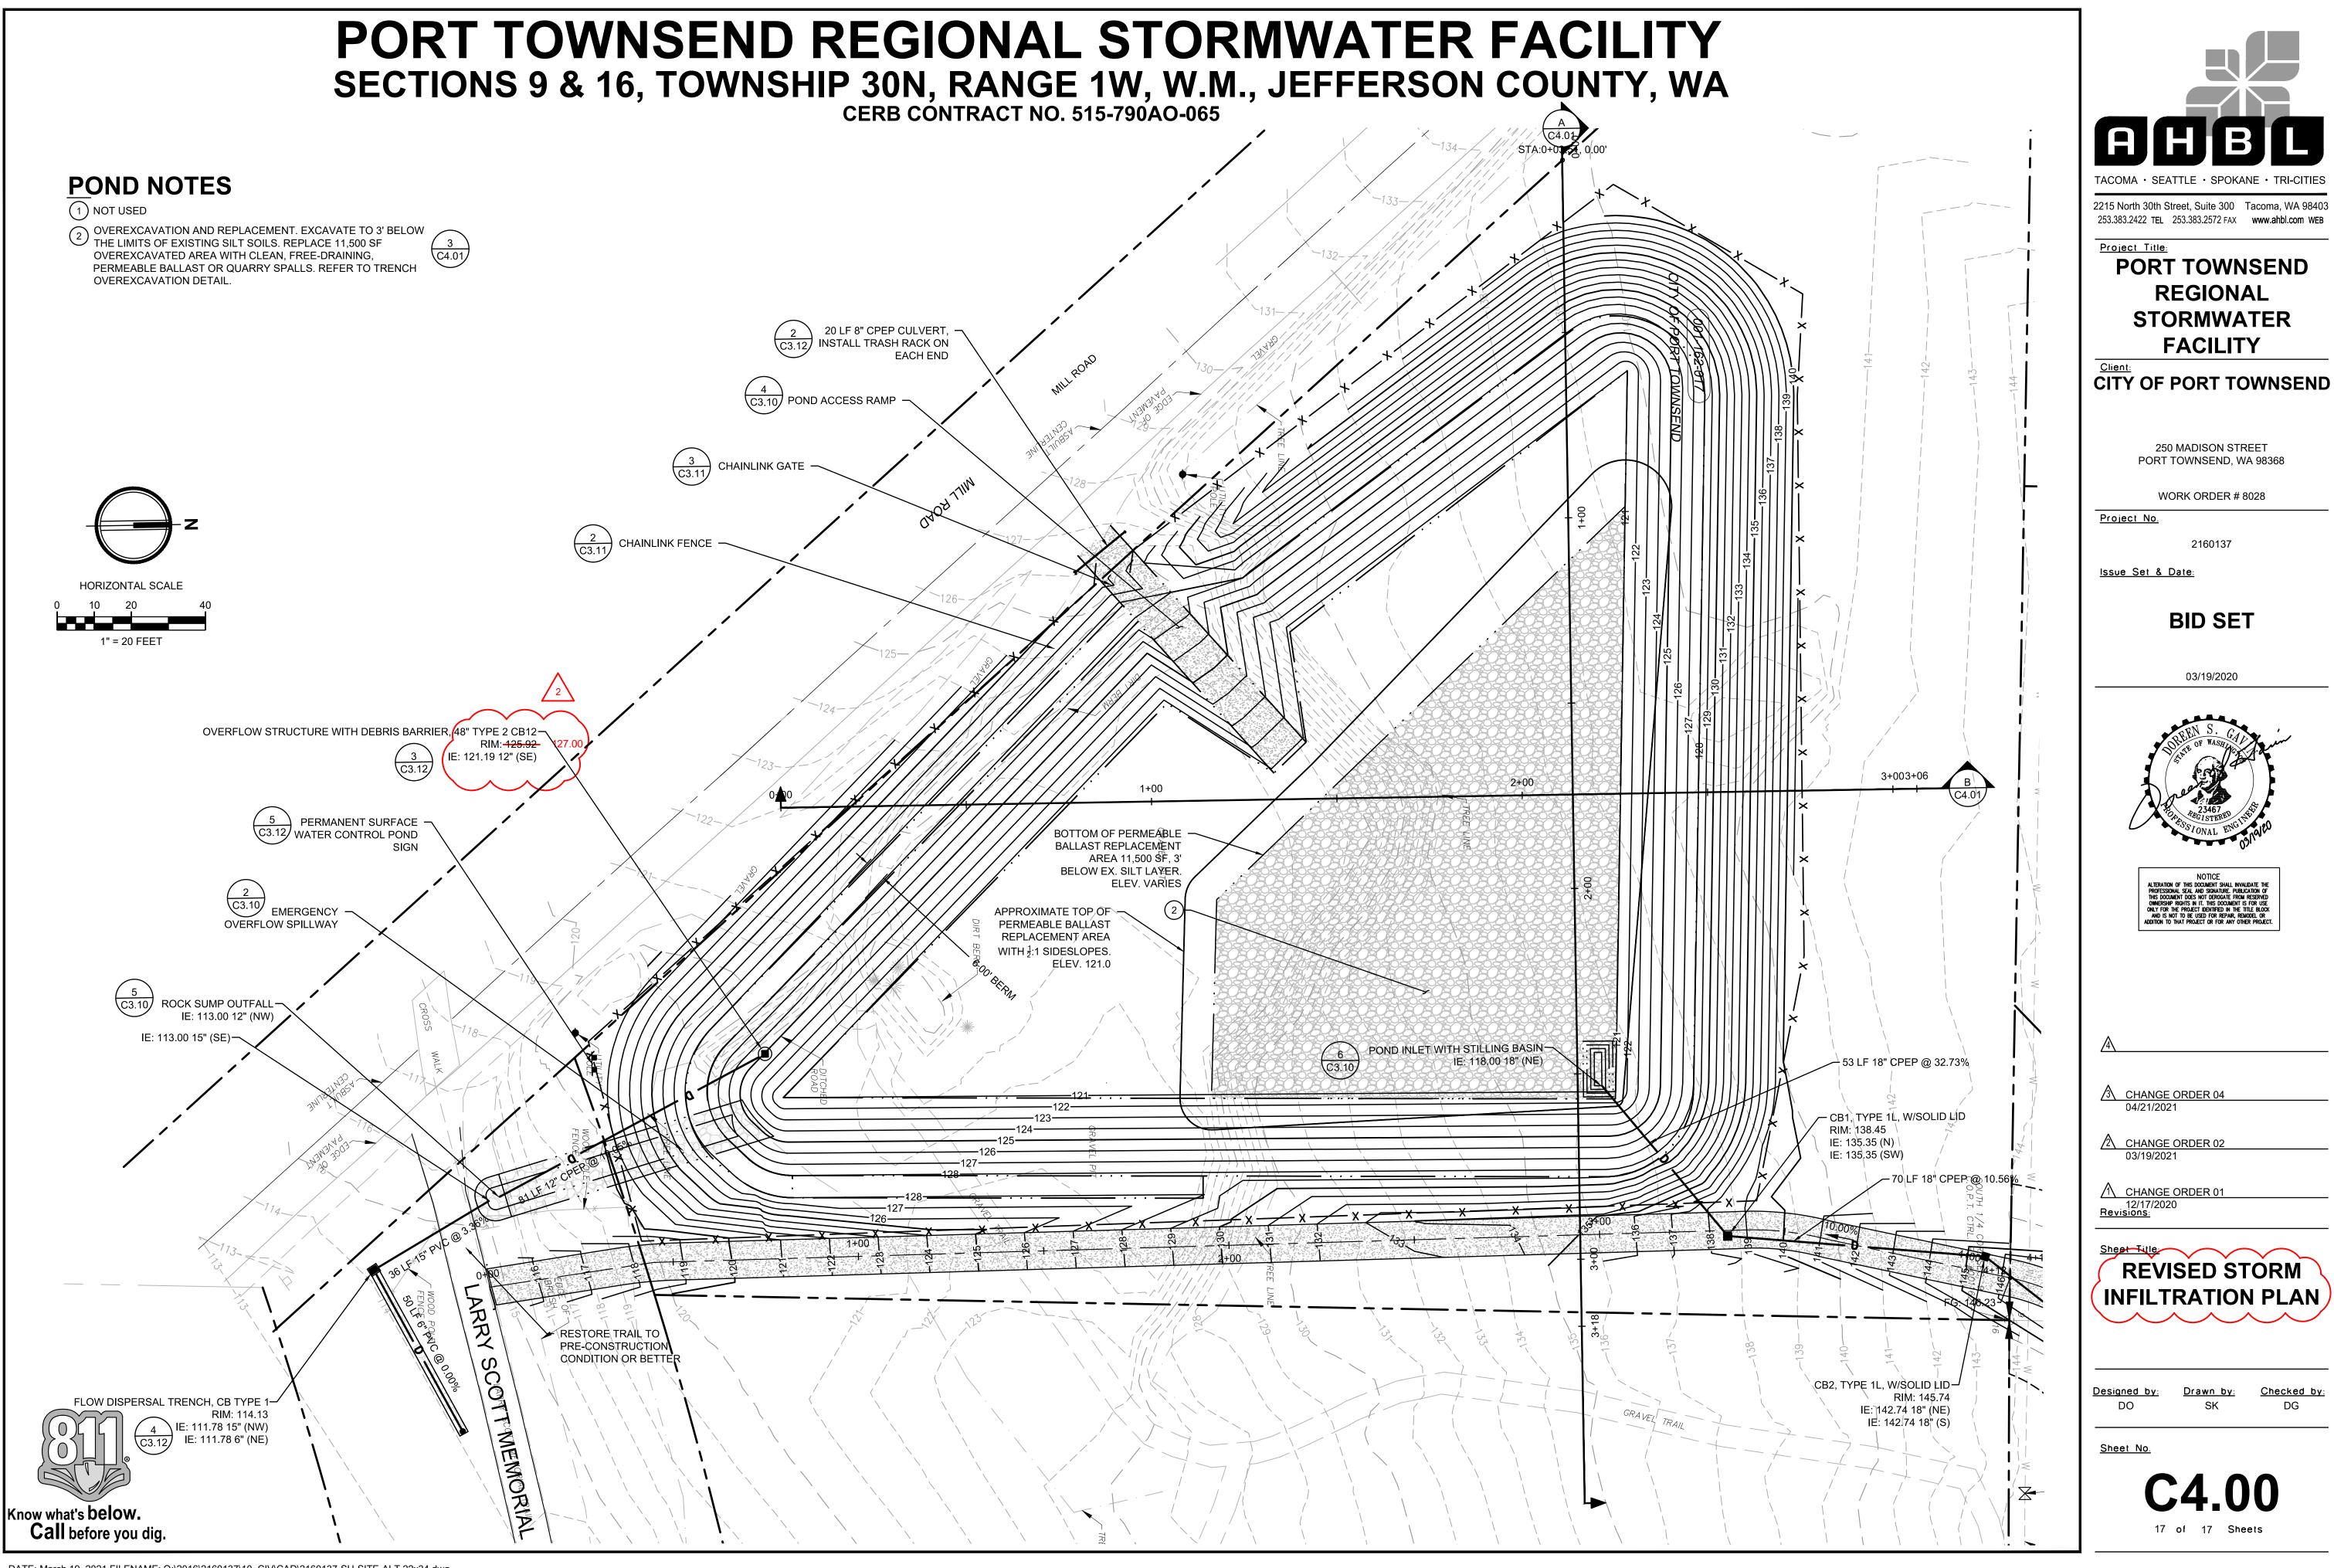
STORM DRAINAGE DETAILS


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CITY OF PORT TOWNSEND

250 MADISON STREET PORT TOWNSEND. WA 98368

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<u>Project No.</u>

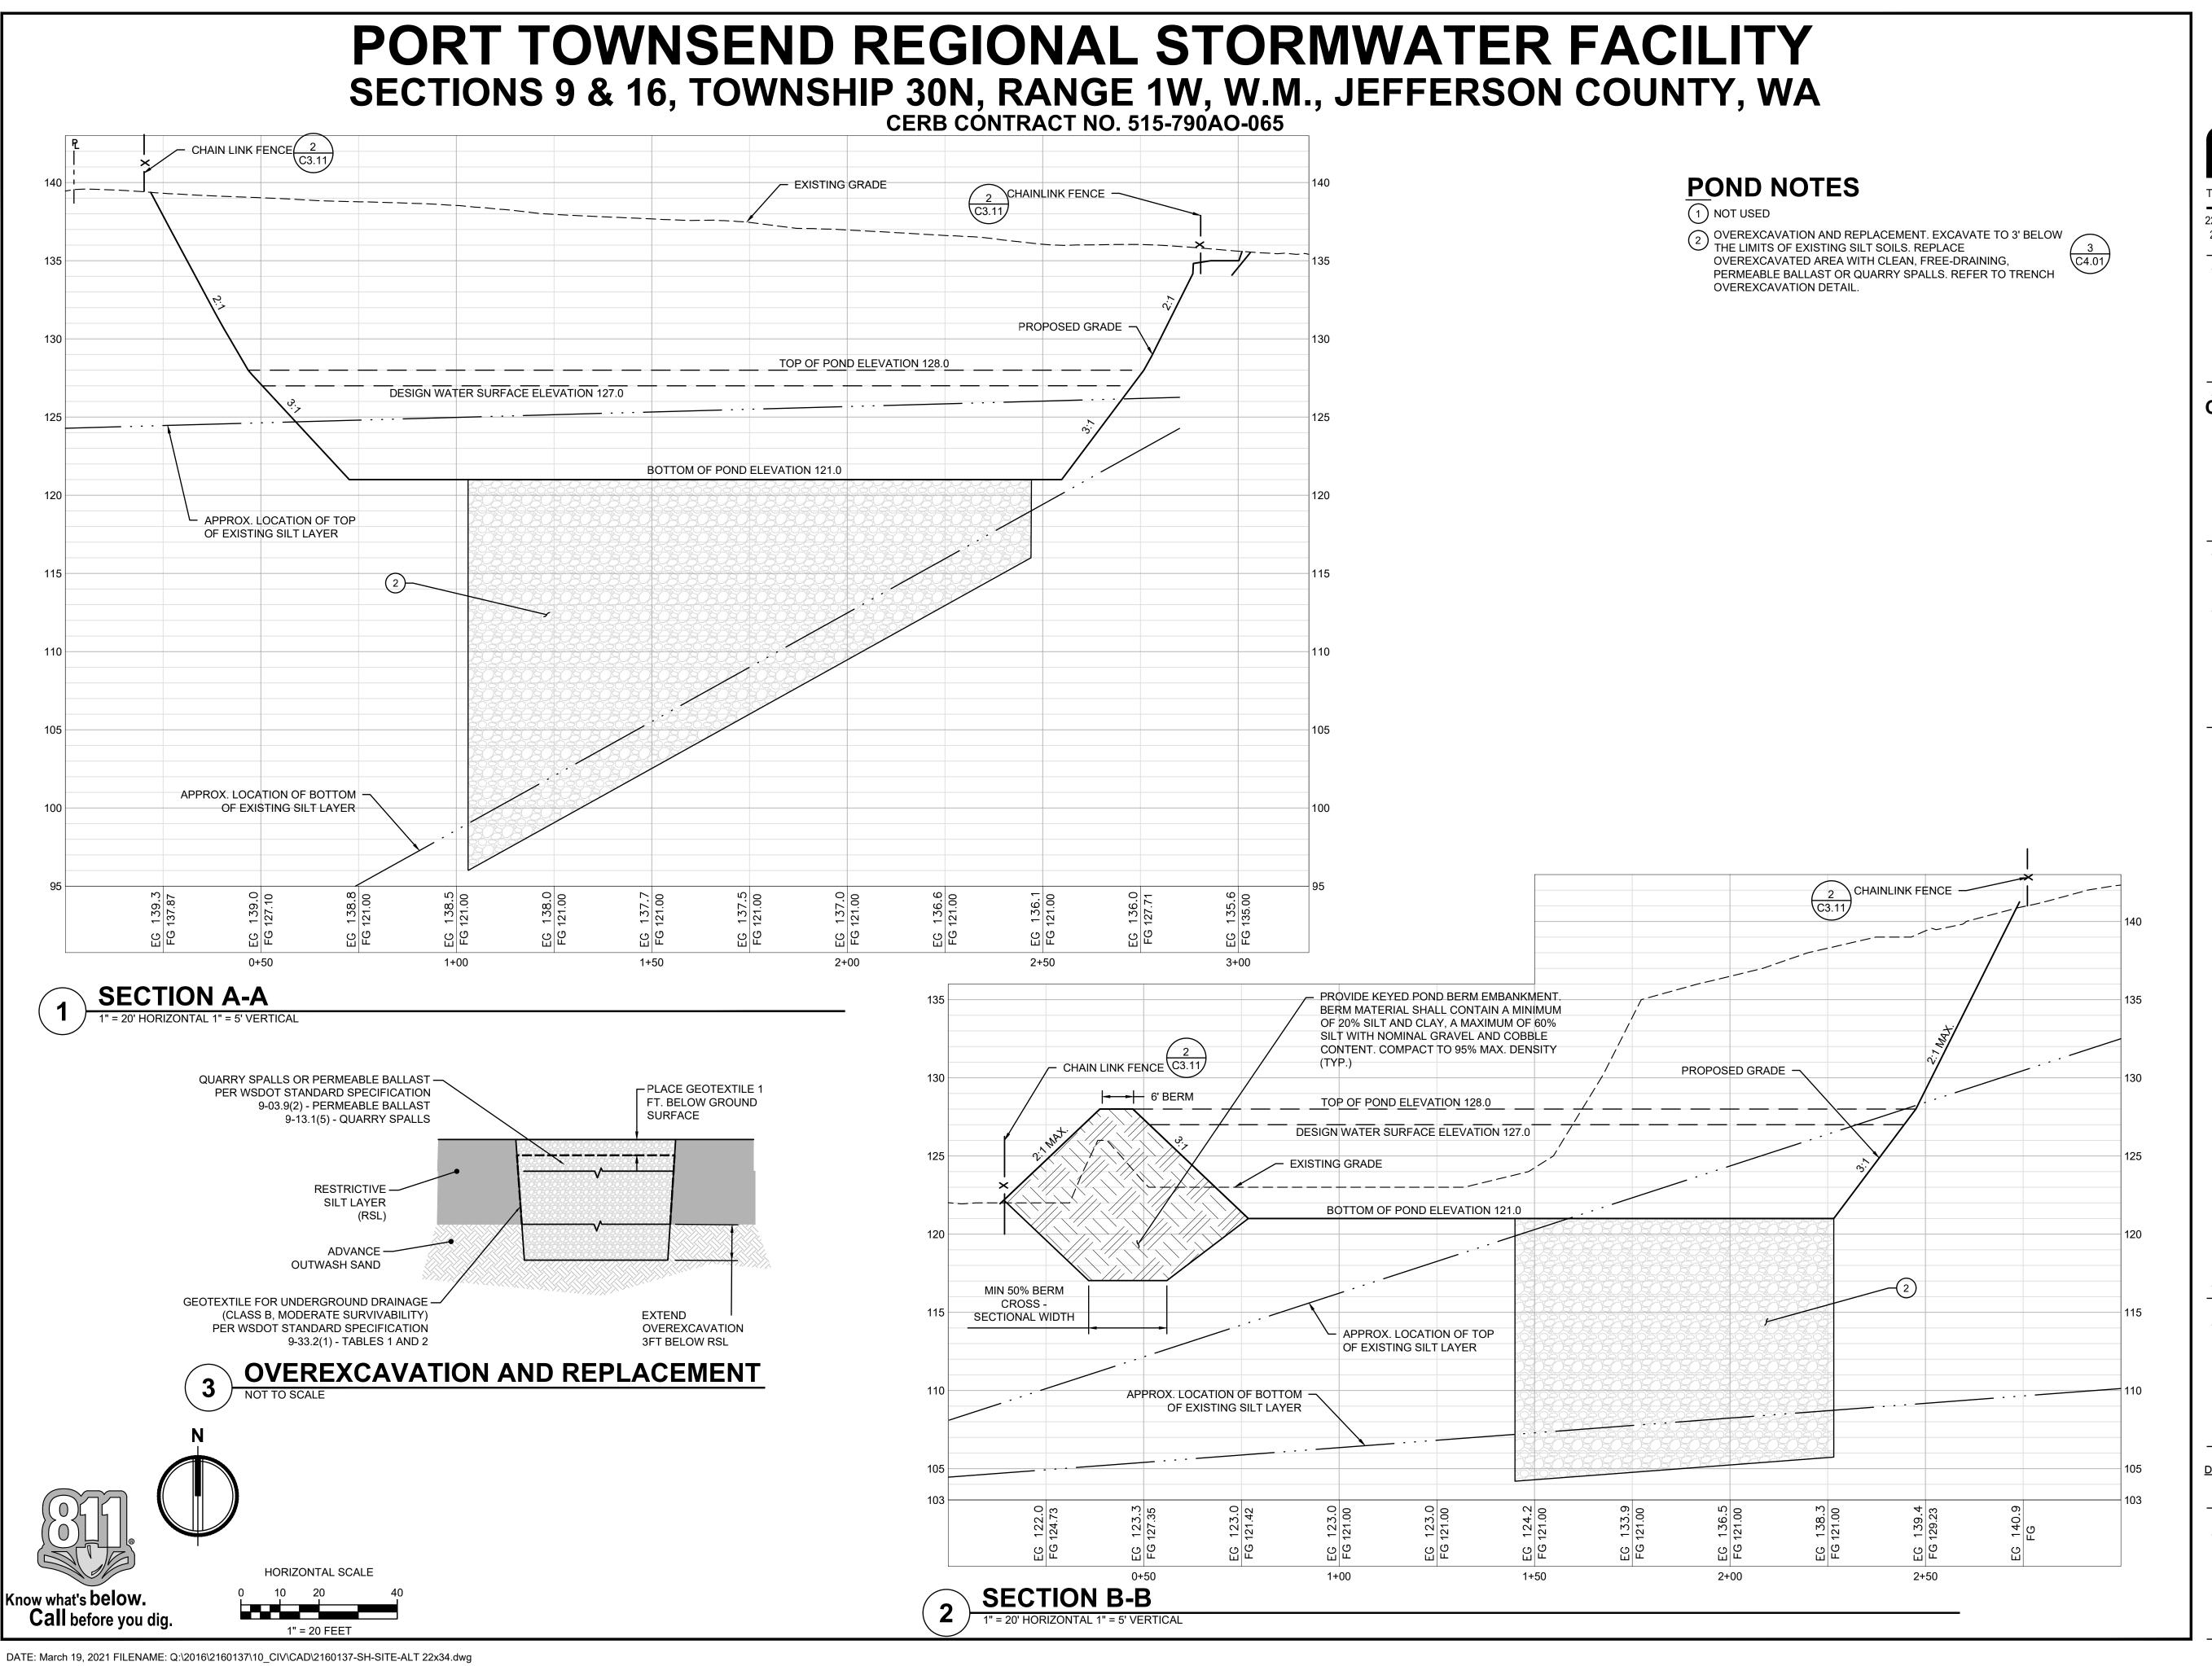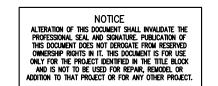
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